1050 MARKHAM ROAD

TORONTO, ON

<u>CLIENT</u>

CAPREIT

11 CHURCH STREET, SUITE 401, TORONTO, ON M5E 1W1

ARCHITECT

WALLMAN ARCHITECTS

99 SPADINA AVENUE, SUITE 600, TORONTO, ONTARIO, M5V 3P8

ISSUED FOR ZBA:

JUNE 07, 2024

ARCHITECTURAL DRAWING LIST

A1 GENERAL

- A1.00 COVER PAGE
- A1.01 LEGAL SURVEY
- A1.02 PROJECT STATISTICS
- A1.03 TGS STATISTICS A1.04 CONTEXT PLAN
- A1.04 CONTEXT P A1.06 SITE PLAN
- A1.10 SITE PLAN ROOF PLAN
- A1.11 SITE PLAN GROUND FLOOR
- A1.12 GREEN ROOF DIAGRAM BUILDING A
- A1.13 GREEN ROOF DIAGRAM BUILDING B
- A1.20 AREA DIAGRAMS
- A1.21 AREA DIAGRAMSA1.22 AMENITY DIAGRAMS

A2 FLOOR PLANS

A2.01 LOWER P2 & P3 PARKING LEVEL

- A2.02 PARKING LEVEL 2
- A2.03 PARKING LEVEL 1
- A2.04 LEVEL 1 FLOOR PLAN
- A2.05 LEVEL 2 FLOOR PLAN A2.08 LEVEL 3 FLOOR PLAN
- A2.08 LEVEL 3 FLOOR PLAN A2.09 LEVEL 4 FLOOR PLAN
- A2.10 LEVEL 5 FLOOR PLAN
- A2.12 LEVEL 7 FLOOR PLAN
- A2.13 OVERALL TYPICAL TOWER FLOOR PLAN
- A2.14 MECHANICAL PENTHOUSE
- A2.15 ROOF PLAN

A3 ELEVATIONS

- A3.01 NORTH ELEVATIONS
- A3.02 EAST ELEVATIONS
- A3.03 SOUTH ELEVATIONSA3.04 WEST ELEVATIONS

A4 BUILDING SECTIONS

A4.01	BUILDING SECTION A - A
A4.02	BUILDING SECTION B - B

- A4.02 BUILDING SECTION C C
- A4.04 BUILDING SECTION D D
- A4.05 BUILDING SECTION E E
- A4.06 WALL SECTIONS BUILDING B

A5 COLOURED ELEVATIONS & RENDERINGS A5.02 PERSPECTIVES

A6 SHADOW STUDIES

A6.01	SHADOW STUDIES MARCH
A6.02	SHADOW STUDIES MARCH
A6.03	SHADOW STUDIES SEPTEMBER
A6.04	SHADOW STUDIES SEPTEMBER
A6.06	SHADOW STUDIES JUNE
A6.07	SHADOW STUDIES JUNE



1. Copyright of this drawing is reserved by the Architect. The drawing, and all associated documents are instruments of service by the Architect. The drawing, and the information contained therein, may not be reproduced in whole or in part without prior written permission of the Architect.

2. These Contract Documents are the property of the Architect. The Architect bears no responsibility for the interpretation of these documents by the Contractor. Upon written application the Architect will provide written/graphic clarification or supplementary information regarding the intent of the Contract Documents. The Architect will review Shop Drawings submitted by the Contractor for design conformance only.

3. Drawings are not to be scaled for construction. The Contractor is to verify all existing conditions and dimensions required to perform the work and report and discrepancies with the Contract Documents to the Architect before commencing any work.

4. Positions of exposed finishes for mechanical or electrical devised, fitting and fixtures are indicated on architectural drawings. The location shown on the architectural drawing govern over the mechanical and electrical drawings. Those items not clearly located will be located as directed by the Architect.

5. These drawings are not to be used for construction unless noted below as "Issued for Construction".

6. All work is to be carried out in conformance with the Code and Bylaws of the Authorities having jurisdiction.

7. The Architect of these plans and specifications gives no warranty or representation to any party about the constructability of the building(s) represented by them. All contractors or subcontractors must satisfy themselves when bidding and at all times ensure that they can properly construct the work represented by these plans.

No	Issued For	Date
1	Issued for ZBA	2024-06-07

WALLMANARCHITECTS

99 Spadina Avenue, Suite 600 Toronto, Ontatrio M5V 3P8 t 416 340 1870 f 416 340 1871 www.wallmanarchitects.com



Project

1050 Markham Road

1050 Markham Road, Toronto, Ontario, M1H 2Y5


Client

CAPREIT


Drawing Title

COVER PAGE

	Scale
	Drawn by
	Checked by
23-11	Project No.
2024-06-07	Date

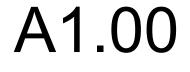

Drawing No.

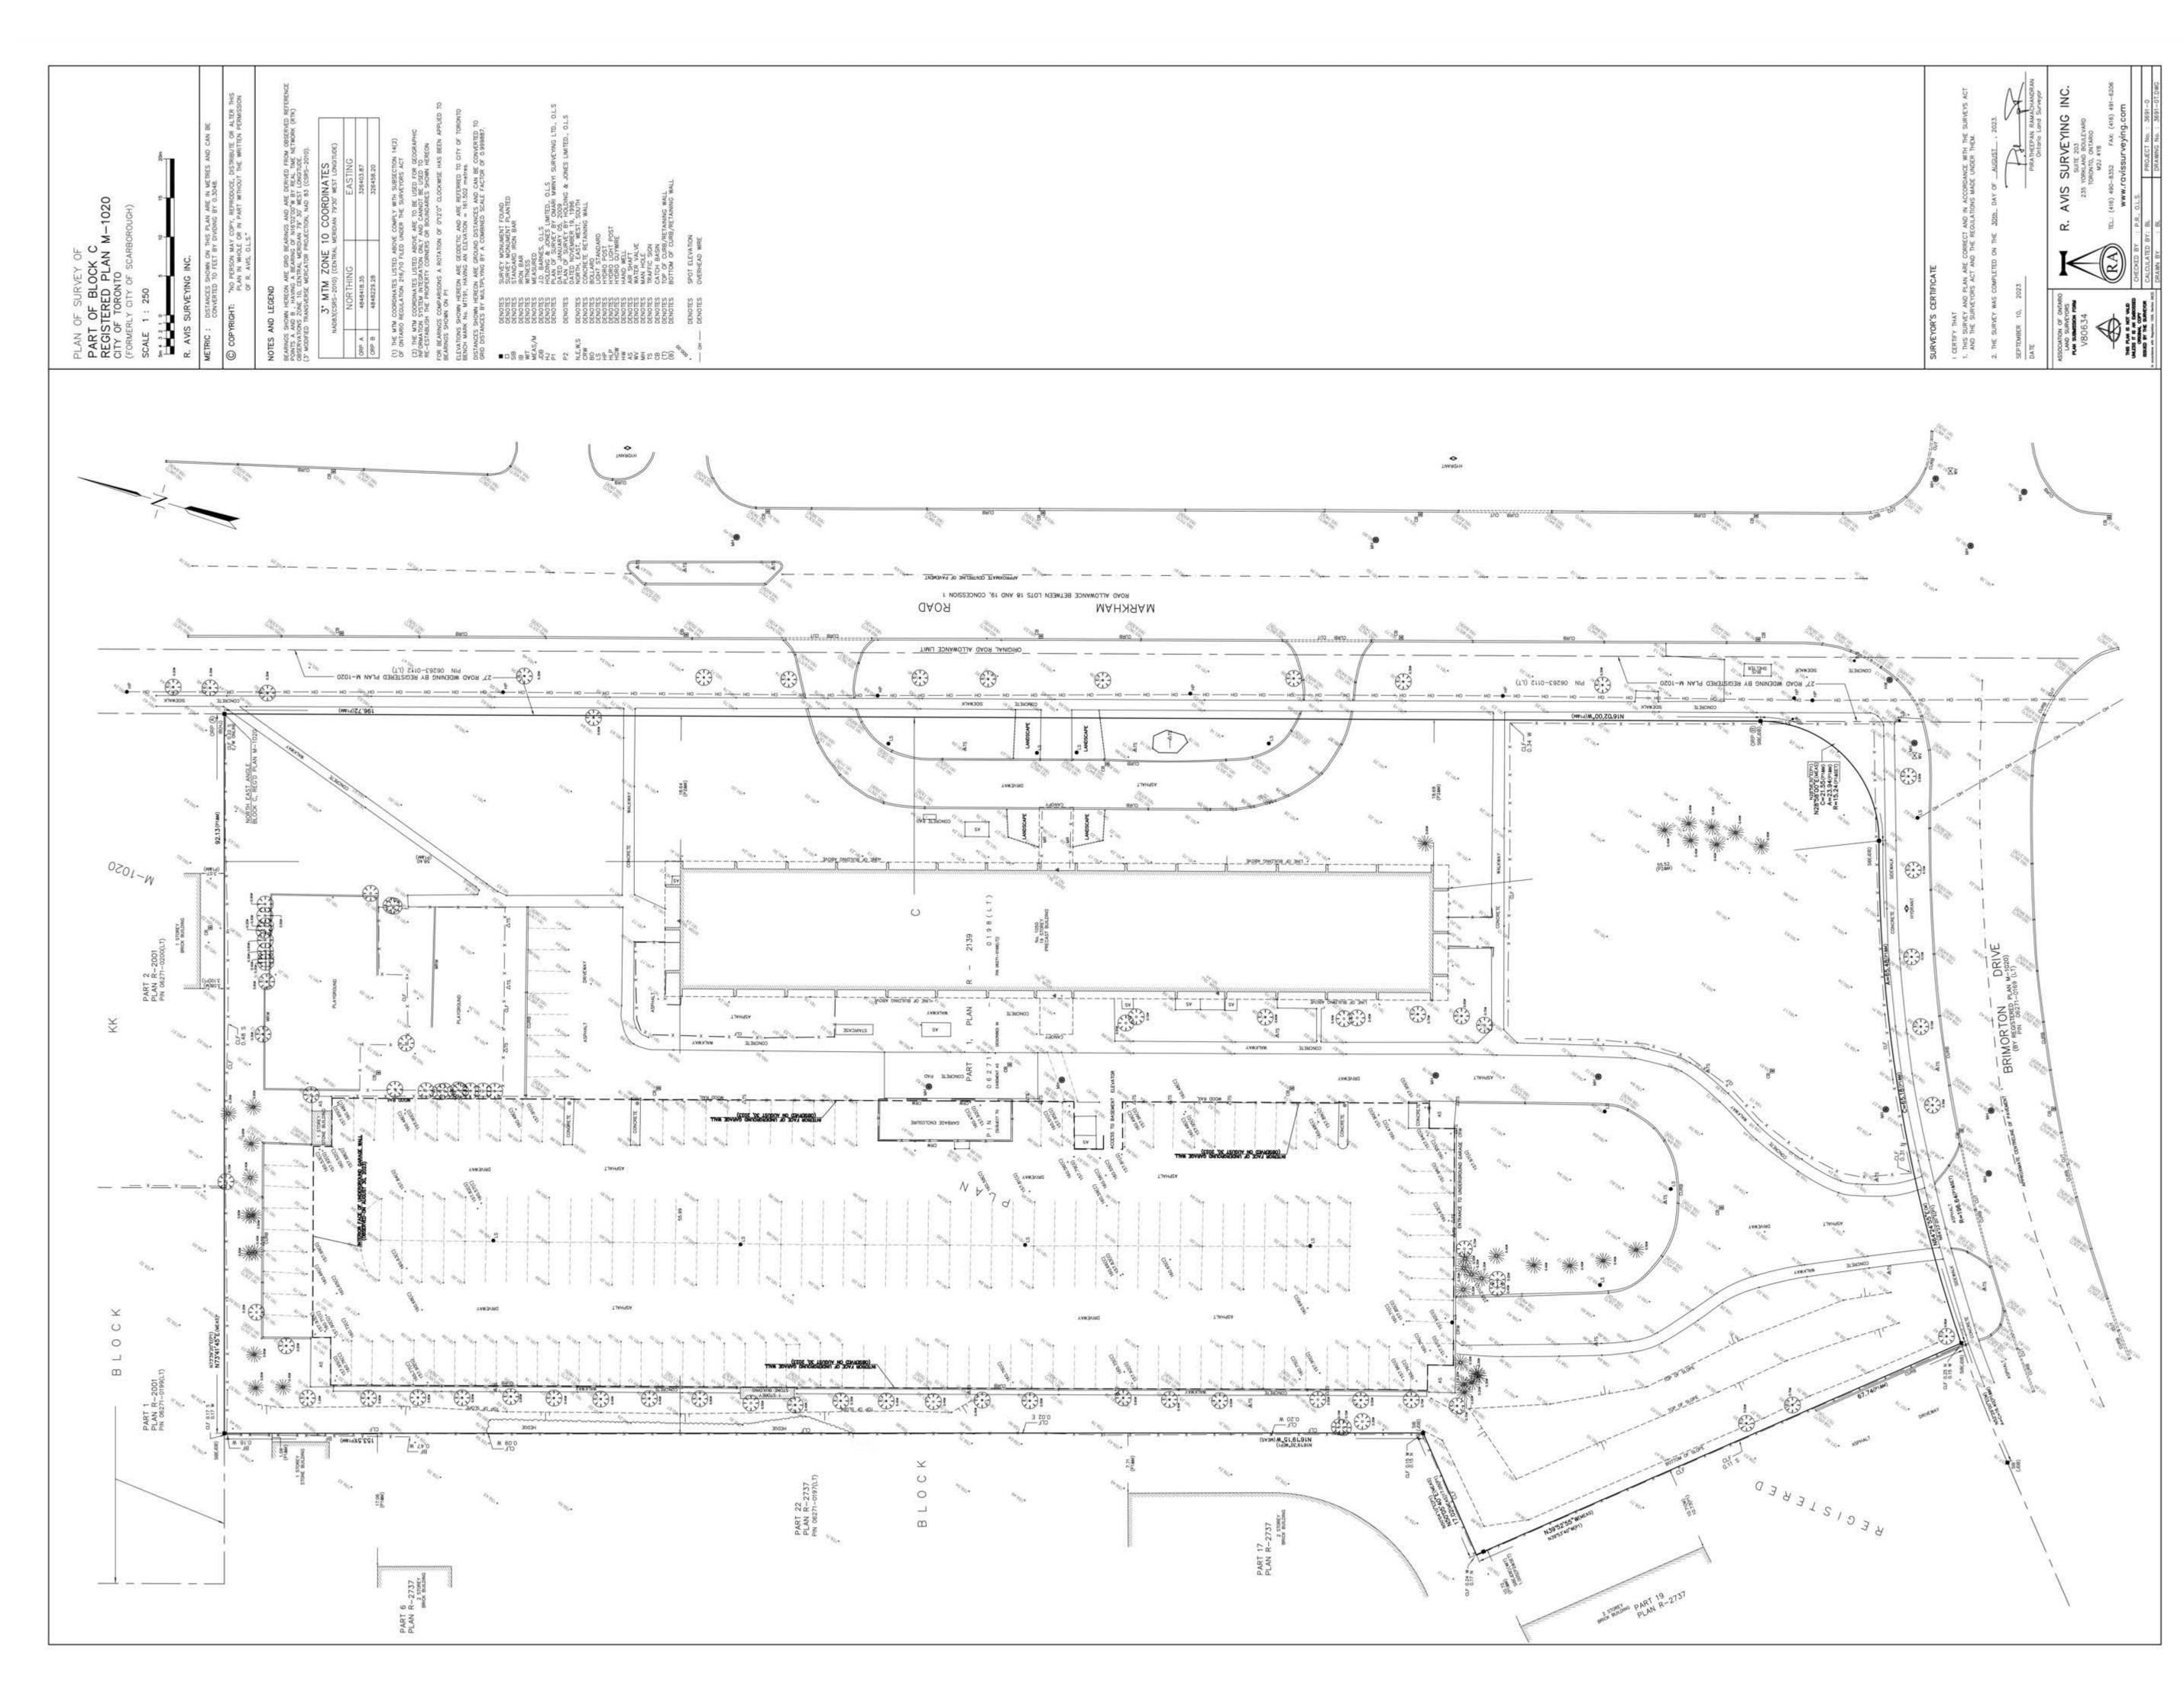

Plot Date: 2024-06-07 4:17:27 PMFile Path: Y: \06 Temporary Files_Revit Default Path\Annya\23-11_1050 Markham Road_acavalcanteHJSTQ

1. Copyright of this drawing is reserved by the Architect. The drawing, and all associated documents are instruments of service by the Architect. The drawing, and the information contained therein, may not be reproduced in whole or in part without prior written permission of the Architect.

2. These Contract Documents are the property of the Architect. The Architect bears no responsibility for the interpretation of these documents by the Contractor. Upon written application the Architect will provide written/graphic clarification or supplementary information regarding the intent of the Contract Documents. The Architect will review Shop Drawings submitted by the Contractor for design conformance only.

3. Drawings are not to be scaled for construction. The Contractor is to verify all existing conditions and dimensions required to perform the work and report and discrepancies with the Contract Documents to the Architect before commencing any work.

4. Positions of exposed finishes for mechanical or electrical devised, fitting and fixtures are indicated on architectural drawings. The location shown on the architectural drawing govern over the mechanical and electrical drawings. Those items not clearly located will be located as directed by the Architect.

5. These drawings are not to be used for construction unless noted below as "Issued for Construction".

6. All work is to be carried out in conformance with the Code and Bylaws of the Authorities having jurisdiction.

7. The Architect of these plans and specifications gives no warranty or representation to any party about the constructability of the building(s) represented by them. All contractors or subcontractors must satisfy themselves when bidding and at all times ensure that they can properly construct the work represented by these plans.

No	Issued For	Date
1	Issued for ZBA	2024-06-07

WALLMANARCHITECTS

99 Spadina Avenue, Suite 600 Toronto, Ontatrio M5V 3P8 t 416 340 1870 f 416 340 1871 www.wallmanarchitects.com



Project

1050 Markham Road

1050 Markham Road, Toronto, Ontario, M1H 2Y5

Client

CAPREIT

Drawing Title

Drawing No.

LEGAL SURVEY

	Scale
	Drawn by
	Checked by
23-11	Project No.
2024-06-07	Date

A1.01

1050 Markham Road **Project Statistics** June 6, 2024

BUILDING INFORMATION Building Height: 37 Storey + 15 Storey

Site Stats	By law 569-2013	
Gross Site Area	19.860.2 m ²	
Net Development Site Area (South Site)	5,151.6 m ²	
Building A & B Combined GFA	39,911.1 m	
FSI of New Development	7.7	

	UNIT COUNT	GCA (Above&Below Grade)		GFA (Above&Below Grade)		PARKING COUNT
1		(m ²)	(sf)	(m ²)	(sf)	
BUILDING A (37 Storeys)	438	35,982.4	387,311	27,469.1	295,674	105
BUILDING B (15 Storeys)	197	18,998.4	204,498	12,442.1	133.926	103
COMBINED	635	54,980.8	591,809	39,911.1	429,600	208
						0.33

*Refer to Traffic Report prepar	ed by LEA for addition	nal detail				
	Unit Count	Min. Required Spaces		Max. Allowed Spaces		Required Accessible Space
		Rate	Total	Rate	Total	
BUILDING A						
1-Bedroom	304		0	0.8	243.2	
2-Bedroom	89		0	0.9	80.1	
3-Bedroom	45		0	1.1	49.5	12
RESIDENTIAL SUBTOTAL			0		373	
Visitor Spaces	438	2 + 0.05*unit	23.9		48	
TOTAL (Bldg A)			23.9		421	12
BUILDING B			-		Ż	
1-Bedroom	146		0	0.8	116.8	
2-Bedroom	32		0	0.9	28.8	
3-Bedroom	19		0	1.1	20.9	
RESIDENTIAL SUBTOTAL			0		167	7
Visitor Spaces	197	2 + 0.05*unit	11.9		24	
TOTAL (Bidg B)			11.9		191	7

GCA	54
Loading Area	
Parking Area	5
Total	4

Green Roof GFA

LEVEL	RESIDENTIAL			
	Accessible	Typical		
SUILDING A			T	
11	0	0	Т	
P1	0	σ		
P2	5	39		
P3	5	33		
Sub-Total	10	72	T	
TOTAL (Bidg A)	8	1	T	
Rate/Unit	0.3	9	1	
BUILDING B	1		Т	
11	0	0	Т	
P1	0	25		
P2	5	48		
P2 Lower	0	14		
Sub-Total	5	87		
TOTAL (Bidg B)	9	2	1	
Rate/Unit	0,4	7		

	Level 1	P1 Level	P2 Level	P3/P2 Lower Level	TOTALS
BUILDING A					
Short Term Spaces	4	28	2852	1.000	32
Long Term Spaces		162	42	95	299
TOTAL (Bldg A)					331
BUILDING B					
Short Term Spaces	20	0 30	12.201		20
Long Term Spaces		30	86	31	147
TOTAL (Bidg B)					167

	67500 CLIMINE 00045 CLIMA	MIN REQUIRED	PROVIDED
(i	Required Rate/Formula	(m2)	(m2)
BUILDING A			
Waste Storage Room	[(Unit Count-50)x0.26]+25	125.9	136.1
Household Hazardous Waste R/	1sqm for every 100 units	4.4	
Bulky Waste Storage	Min 10sm	10.0	10.0
Staging Area	[(Unit Count-50)/50]x5+5	43.8	44.5
BUILDING B			
Waste Storage Room	[(Unit Count-50)x0.26]+25	63.2	142.2
Household Hazardous Waste R-	1sqm for every 100 units	2.0	
Bulky Waste Storage	Min 10sm	10.0	10.0
Staging Area	[(Unit Count-50)/50]x5+5	19.7	58.4
EXISTING 19 STOREY BLDG (295 U	NITS)		
Waste Storage Room	[[Unit Count-50]x0.26]+25	88.7	
Staging Area	[{Unit Count-50]/50]x5+5	29.5	


Building B Staging Area sized to provide loading for Building B + Existing 19 storey building

ICYCLE PARKING REQUIRED	ZBL 569-2013 BIKE ZONE B)	1

100

	Unit Count		Bike Spaces per unit	Min. Required
BUILDING A				
Short Term Spaces	438	x	0.07	31
Long Term Spaces	438	×	0.68	298
TOTAL (Bidg A)				329
BUILDING B		1		
Short Term Spaces	197	×	0.07	14
Long Term Spaces	197	×	0.68	134
TOTAL (Bidg B)		-		148

	Unit Count	Indoor J	Amenity	Outdoor	Amenity
	1.66.0647.0025	(m ²)	[st]	(m ²)	(11)
BUILDING A					
LEVEL 1		313.3	3,372	297.9	3,206
LEVEL 2		458.1	4,931	153.7	1,654
TOTAL (Bidg A)	438	771.39	8,303	451.6	4,861
BUILDING B			1010		
LEVEL 1		199.6	2,148	708.8	7,630
LEVEL 2		306.4	3,298	123.77	1,332
TOTAL (Bidg B)	197	505.95	5,446	832.6	8,962
COMBINED TOTAL	635	1277.3	13,749	1284.2	13,823
(BLDG A + B)	Sq. m PER UNIT	2.0		2.0	

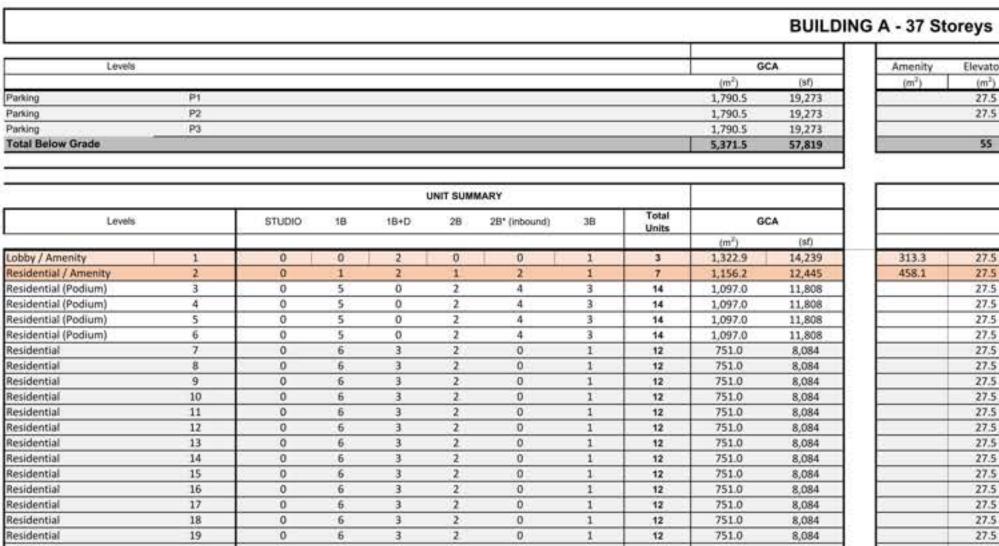

751.0

751.0

751.0

751.0

751.0

12

12

12

12

1 12 751.0

1 12 751.0

12

8,084

8,084

8,084

8,084

8,084

8,084

8,084

Deductions

VISI	TOR	TOTAL
cessible	Typical	
0	0	0
2	21	23
0	0	44
0	0	38
2	21	102.005
2	3	105
0.	05	0.24
0	0	0
2	9	36 53
0	0	14
2	9	- A.
	1	103
	06	0.52
2 Level	P3/P2 Lower Level	TOTALS
	4.04	32

idential

idential

idential

idential

sidential

sidential

sidential

Building B Waste Storage Room sized to provide waste storage for organics and garbage bins from the existing building

nesidentia	20	0	9.			U		14	134.0	0,004		61.3
Residential	27	0	6	3	2	0	1	12	751.0	8,084		27.5
Residential	28	0	6	3	2	0	1	12	751.0	8,084		27.5
Residential	29	0	б	3	2	0	1	12	751.0	8,084	1	27.5
Residential	30	0	6	3	2	0	1	12	751.0	8,084	3	27.5
Residential	31	0	6	3	2	0	1	12	751.0	8,084	2 · · · · ·	27.5
Residential	32	0	6	3	2	0	1	12	751.0	8,084	6	27.5
Residential	33	0	6	3	2	0	1	12	751.0	8,084		27.5
Residential	34	0	6	3	2	0	1	12	751.0	8,084		27.5
Residential	35	0	6	3	2	0	1	12	751.0	8,084	5	27,5
Residential	36	0	6	3	2	0	1	12	751.0	8,084		27.5
Residential Penthouse	37	0	6	3	2	0	1	12	751.0	8,084		27.5
Mechanical Penthouse									462.1	4,974		
Total Above Grade		0	207	97	71	18	45	438	30,610.9	329,493	<u>1</u>	
		0.0%	47.3%	22.1%	16.2%	4.1%	10.3%					
		0%	64	9%	1	20.3%	10.3%					
Average Unit Size (sf)		0	5	09		690	882					
Total Above & Below Grade	0								35,982.4	387,311	2	
										BUILDIN	IG B - 15 St	oreys
Levels									G	CA	Amenity	Elevators
									(m ²)	(sf)	(m ²)	(m ²)
Parking	P1								2,327.0	25,048	2	23.2
Parking	P2								2,327.0	25,048	0	23.2
	1.2.27											
Total Below Grade								1	4,654.0	50,095	<u>1</u>	46.4
											-	
	500 a stat	n of all heads the	···· · · · · ·	course M	UNIT SUMM			Total				
	Levels	STUDIO	18	1B+D	UNIT SUMM 2B	IARY 2B* (inbound)	3B	Total Units		CA		
	Levels	STUDIO	18	CENTRAL CONTRACT			3B		(m²)	(sf)		
Lobby / Amenity	Lovels	STUDIO 0	18	CENTRAL CONTRACT			38 1			22Y	199.6	23.2

	Levels	STUDIO	1B	1B+D	2B	2B* (inbound)	3B	Units	GG	A
			1.011						(m ²)	(sf)
Lobby / Amenity	1	0	2	4	0	0	1	7	1434.6	15,442
Residential/Amenity	2	0	2	3	2	2	1	10	1267.2	13,640
Residential (Lower Podium)	3	0	4	4	2	4	3	17	1204.0	12,960
Residential (Lower Podium)	4	0	7	6	2	2	1	18	1204.0	12,960
Residential (Lower Podium)	5	0	8	4	0	0	2	14	904.0	9,730
Residential (Upper Podium)	6	0	8	4	0	0	2	14	904.0	9,730
Residential	7	0	7	3	2	0	1	13	776.0	8,352
Residential	8	0	7	3	2	0	1	13	776.0	8,352
Residential	9	0	7	3	2	0	1	13	776.0	8,352
Residential	10	0	7	3	2	0	1	13	776.0	8,352
Residential	11	0	7	3	2	0	1	13	776.0	8,352
Residential	12	0	7	3	2	0	1	13	776.0	8,352
Residential	13	0	7	3	2	0	1	13	776.0	8,352
Residential	14	0	7	3	2	0	1	13	776.0	8,352
Residential	15	0	7	3	2	0	1	13	776.0	8,352
Mechanical Penthouse									443.2	4,770
Total Above Grade		0	94	52	24	8	19	197	14,344.4	154,402
		0.0%	47.7%	26.4%	12.2%	4.1%	9.6%			
		0%	7	4%		16.2%	9.6%			
Average Unit Size (sf)		0	4	98		664	906			
Total Above & Below Grade		110 110 1					11100551		18,998.4	204,498

1050 Markham Existing Total Units 295

		eductions (By	and the second se		
Amenity	Elevators		Garb Chute	MISC	Total Deductio
(m ²)	(m ²)	(m ²)	(m ²)	(m ²)	(m ²)
CR A1 51	27.5	32.76	s see a	1,663.8	1724.1
	27.5	32.76		1,663.8	1724.1
_	55		_	3,327.7	
				5,527.17	
313.3	27.5	38.7	0.0	191.5	571.0
458.1	27.5	18.4	0.3	122.4	626.7
	27.5	18.4	0.3	-	46.1
	27.5	18.4	0.3		46.1
	27.5	18.4	0.3		46.1
				462.1	462.1

GI	A
(m ²)	(81)
66.4	715
66.4	715
132.8	1,430
GI	A
(m ²)	(sf)
751.9	8,093
529.5	5,700
1,050.9	11,312
1,050.9	11,312
1,050.9	11,312
1,050.9	11,312
704.9	7,587
704.9	7,587
704.9	7 597
704.9	7,587
704.9	7,587
704.9	7,587
704.9	7,587
1000	7,587
704.9	7,587
704.9	the second s
	7,587
704.9	7,587
704.9	7,587
704.9	7,587
704.9	7,587
704.9	7,587

704.9 7,587 0.0 0 27,336.2 294,245

TOTAL AVG. UNIT SIZE

27,469.1 295,674

GFA

83.9 903

446

(m²) (sf) 42.5 457

41.4

1. Copyright of this drawing is reserved by the Architect. The drawing, and all associated documents are instruments of service by the Architect. The drawing, and the information contained therein, may not be reproduced in whole or in part without prior written permission of the Architect.

2. These Contract Documents are the property of the Architect. The Architect bears no responsibility for the interpretation of these documents by the Contractor. Upon written application the Architect will provide written/graphic clarification or supplementary information regarding the intent of the Contract Documents. The Architect will review Shop Drawings submitted by the Contractor for design conformance only.

3. Drawings are not to be scaled for construction. The Contractor is to verify all existing conditions and dimensions required to perform the work and report and discrepancies with the Contract Documents to the Architect before commencing any work.

4. Positions of exposed finishes for mechanical or electrical devised, fitting and fixtures are indicated on architectural drawings. The location shown on the architectural drawing govern over the mechanical and electrical drawings. Those items not clearly located will be located as directed by the Architect.

5. These drawings are not to be used for construction unless noted below as "Issued for Construction".

6. All work is to be carried out in conformance with the Code and Bylaws of the Authorities having jurisdiction.

7. The Architect of these plans and specifications gives no warranty or representation to any party about the constructability of the building(s) represented by them. All contractors or subcontractors must satisfy themselves when bidding and at all times ensure that they can properly construct the work represented by these plans.

No	Issued For	Date
1	Issued for ZBA	2024-06-07

WALLMANARCHITECTS

99 Spadina Avenue, Suite 600 Toronto, Ontatrio M5V 3P8 t 416 340 1870 f 416 340 1871 www.wallmanarchitects.com



Project

1050 Markham Road

1050 Markham Road, Toronto, Ontario, M1H 2Y5

CAPREIT

Client

Drawing Title

PROJECT STATISTICS

	Scale
	Drawn by
	Checked by
23-11	Project No.
2024-06-07	Date
	Drowing No.

31.3 0.0 158.3 199.6 23.2 412.4 306,4 26.6 0.3 137.5 493.9 23.2
 23.2
 26.6
 0.3

 23.2
 26.6
 0.3

 23.2
 39.8
 0.3

 23.2
 24.1
 0.3

 23.2
 24.1
 0.3

 23.2
 24.1
 0.3

 23.2
 24.1
 0.3

 23.2
 24.1
 0.3

 23.2
 24.1
 0.3

 23.2
 24.1
 0.3

 23.2
 24.1
 0.3
 50.1 63.3 47.6 47.6 47.6 47.6 47.6 47.6 24.1 0.3 23.Z 23.2 24.1 0.3 47.6 47.6 47.6 23.2 24.1 0.3 23.2 24.1 0.3 47.6 47.6 23.2 24.1 0.3 23.2 24.1 0.3 443.2 443.2

Deductions (Bylaw 569-2013)
 Amenity
 Elevators
 Exit Stairs
 Garb Chute
 MISC
 Total Deduction

 (m²)
 (m²)
 (m²)
 (m²)
 (m²)
 (m²)

23.2 32.76

32.76

46.4

2,228.6 2284.5 2,229.6 2285.6

4,458.2

G	FA
(m ²)	(sf)
1,022.2	11,003
773.3	8,323
1,153.9	12,420
1,140.7	12,279
856.4	9,218
856.4	9,218
728.4	7,840
728,4	7,840
728.4	7,840
728.4	7,840
728.4	7,840
728.4	7,840
728.4	7,840
728.4	7,840
728.4	7,840
0.0	0
12,358.2	133,023

TOTAL AVG. UNIT SIZE 12,442.1 133,926

A1.02

Drawing No.



Statistics Template – Toronto Green Standard Version 4.0 Mid to High Rise Residential and all New Non-Residential Development

The Toronto Green Standard Version 4.0 Statistics Template is submitted with Site Plan Control Applications and stand-alone Zoning Bylaw Amendment applications. Complete the table and copy it directly onto the Site Plan submitted as part of the application.

For Zoning Bylaw Amendment applications: complete General Project Description and Section 1. For Site Plan Control applications: complete General Project Description, Section 1 and Section 2. For further information, please visit www.toronto.ca/greendevelopment

General Project Description		Proposed	
Total Gross Floor Area	39,911.1		
Breakdown of project components (m²):			
Residential	39,911.1		
Retail			
Commercial			
Industrial			
Institutional/Other			
Total number of residential units	635		

Section 1: For Stand Alone Zoning Bylaw Amendment Applications and Site Plan Control Applications

Low Emissions Transportation	Required	Proposed	Proposed %
Number of Parking Spaces	34	208	612%
Number of EV Parking Spaces (Residential)	174	174	100%
Number of EV Parking Spaces (non-residential)	0	0	
Cycling Infrastructure	Required	Proposed	Proposed %
Number of long-term bicycle parking spaces (all-uses)	432	446	103%
Number of long-term bicycle parking located on:		1	
a) first storey of building		0	
b) second storey of building		0	
c) first level below-ground		192	
d) second level below-ground		128	
e) other levels below-ground		126	

📀 🧭 🔕 🙆



D TORONTO

Statistics Template – Toronto Green Standard Version 4.0 Mid to High Rise Residential and all New Non-Residential Development

Cycling Infrastructure	Required	Proposed	Proposed %
Number of short-term bicycle parking spaces	45	50	111%
Number of shower and change facilities (non-residential)	N/A	0	
Tree Canopy	Required	Proposed	Proposed %
Tree Canopy Total Soil Volume (40% of the site area ÷ 66 m2 x 30 m³)	Required 936.65	Proposed 937.05	Proposed %

Section 2: For Site Plan Control Applications

Cycling Infrastructure	Required	Proposed	Proposed %
Number of short-term bicycle parking spaces (all uses) at-grade or on first level below grade			
Number of publicly accessible bicycle parking spaces			
Number of energized outlets for electric bicycles			
Tree Canopy	Required	Proposed	Proposed %
Total site area (m²)			
Total Soil Volume (40% of the site area + 66 m² x 30 m³)			
Total number of trees planted			
Number of surface parking spaces (if applicable)			
Number of shade trees located in surface parking area		-	
Landscaping & Biodiversity	Required	Proposed	Proposed %
Total non-roof hardscape area (m²)			
Total non-roof hardscape area treated for Urban Heat Island (minimum residential 75% or non-residential 50%) (m²)			
Area of non-roof hardscape treated with: (indicate m ²)			
a) high-albedo surface material			
b) open-grid pavement			
c) shade from tree canopy			

D TORONTO

Landscaping & Biodiversity	Required	Proposed	Proposed %
d) shade from high-albedo structures			
e) shade from energy generation structures			
Percentage of Lot Area as Soft Landscaping (non-residential only)			
Total number of plants			
Total number of native plants and % of total plants			
Available Roof Space (m ²)			
Available Roof Space provided as Green Roof (m ²)			
Available Roof Space provided as Cool Roof (m ²)		-	
Available Roof Space provided as Solar Panels (m ²)		2	
Bird Collision Deterrence	Required	Proposed	Proposed %
Total area of glazing of all elevations within 16m above grade			

total area of glo Total area of tre glazing within 1 Percentage of g a) Visua b) non-r

c) Buildir

Statistics Template - Toronto Green Standard Version 4.0 Mid to High Rise Residential and all New Non-Residential Development

Page 3 of 3

1. Copyright of this drawing is reserved by the Architect. The drawing, and all associated documents are instruments of service by the Architect. The drawing, and the information contained therein, may not be reproduced in whole or in part without prior written permission of the Architect.

2. These Contract Documents are the property of the Architect. The Architect bears no responsibility for the interpretation of these documents by the Contractor. Upon written application the Architect will provide written/graphic clarification or supplementary information regarding the intent of the Contract Documents. The Architect will review Shop Drawings submitted by the Contractor for design conformance only.

3. Drawings are not to be scaled for construction. The Contractor is to verify all existing conditions and dimensions required to perform the work and report and discrepancies with the Contract Documents to the Architect before commencing any work.

 Positions of exposed finishes for mechanical or electrical devised, fitting and fixtures are indicated on architectural drawings. The location shown on the architectural drawing govern over the mechanical and electrical drawings. Those items not clearly located will be located as directed by the Architect.

5. These drawings are not to be used for construction unless noted below as "Issued for Construction".

All work is to be carried out in conformance with the Code and Bylaws of the Authorities having jurisdiction.

7. The Architect of these plans and specifications gives no warranty or representation to any party about the constructability of the building(s) represented by them. All contractors or subcontractors must satisfy themselves when bidding and at all times ensure that they can properly construct the work represented by these plans.

Date No Issued For 1 Issued for ZBA 2024-06-07

WALLMANARCHITECTS

99 Spadina Avenue, Suite 600 Toronto, Ontatrio M5V 3P8 t 416 340 1870 f 416 340 1871 www.wallmanarchitects.com



Project

1050 Markham Road

1050 Markham Road, Toronto, Ontario, M1H 2Y5

Client

CAPREIT


Drawing No.

TGS STATISTICS

	Scale
	Drawn by
	Checked by
23-11	Project No.
2024-06-07	Date

A1.03

Drawing Title

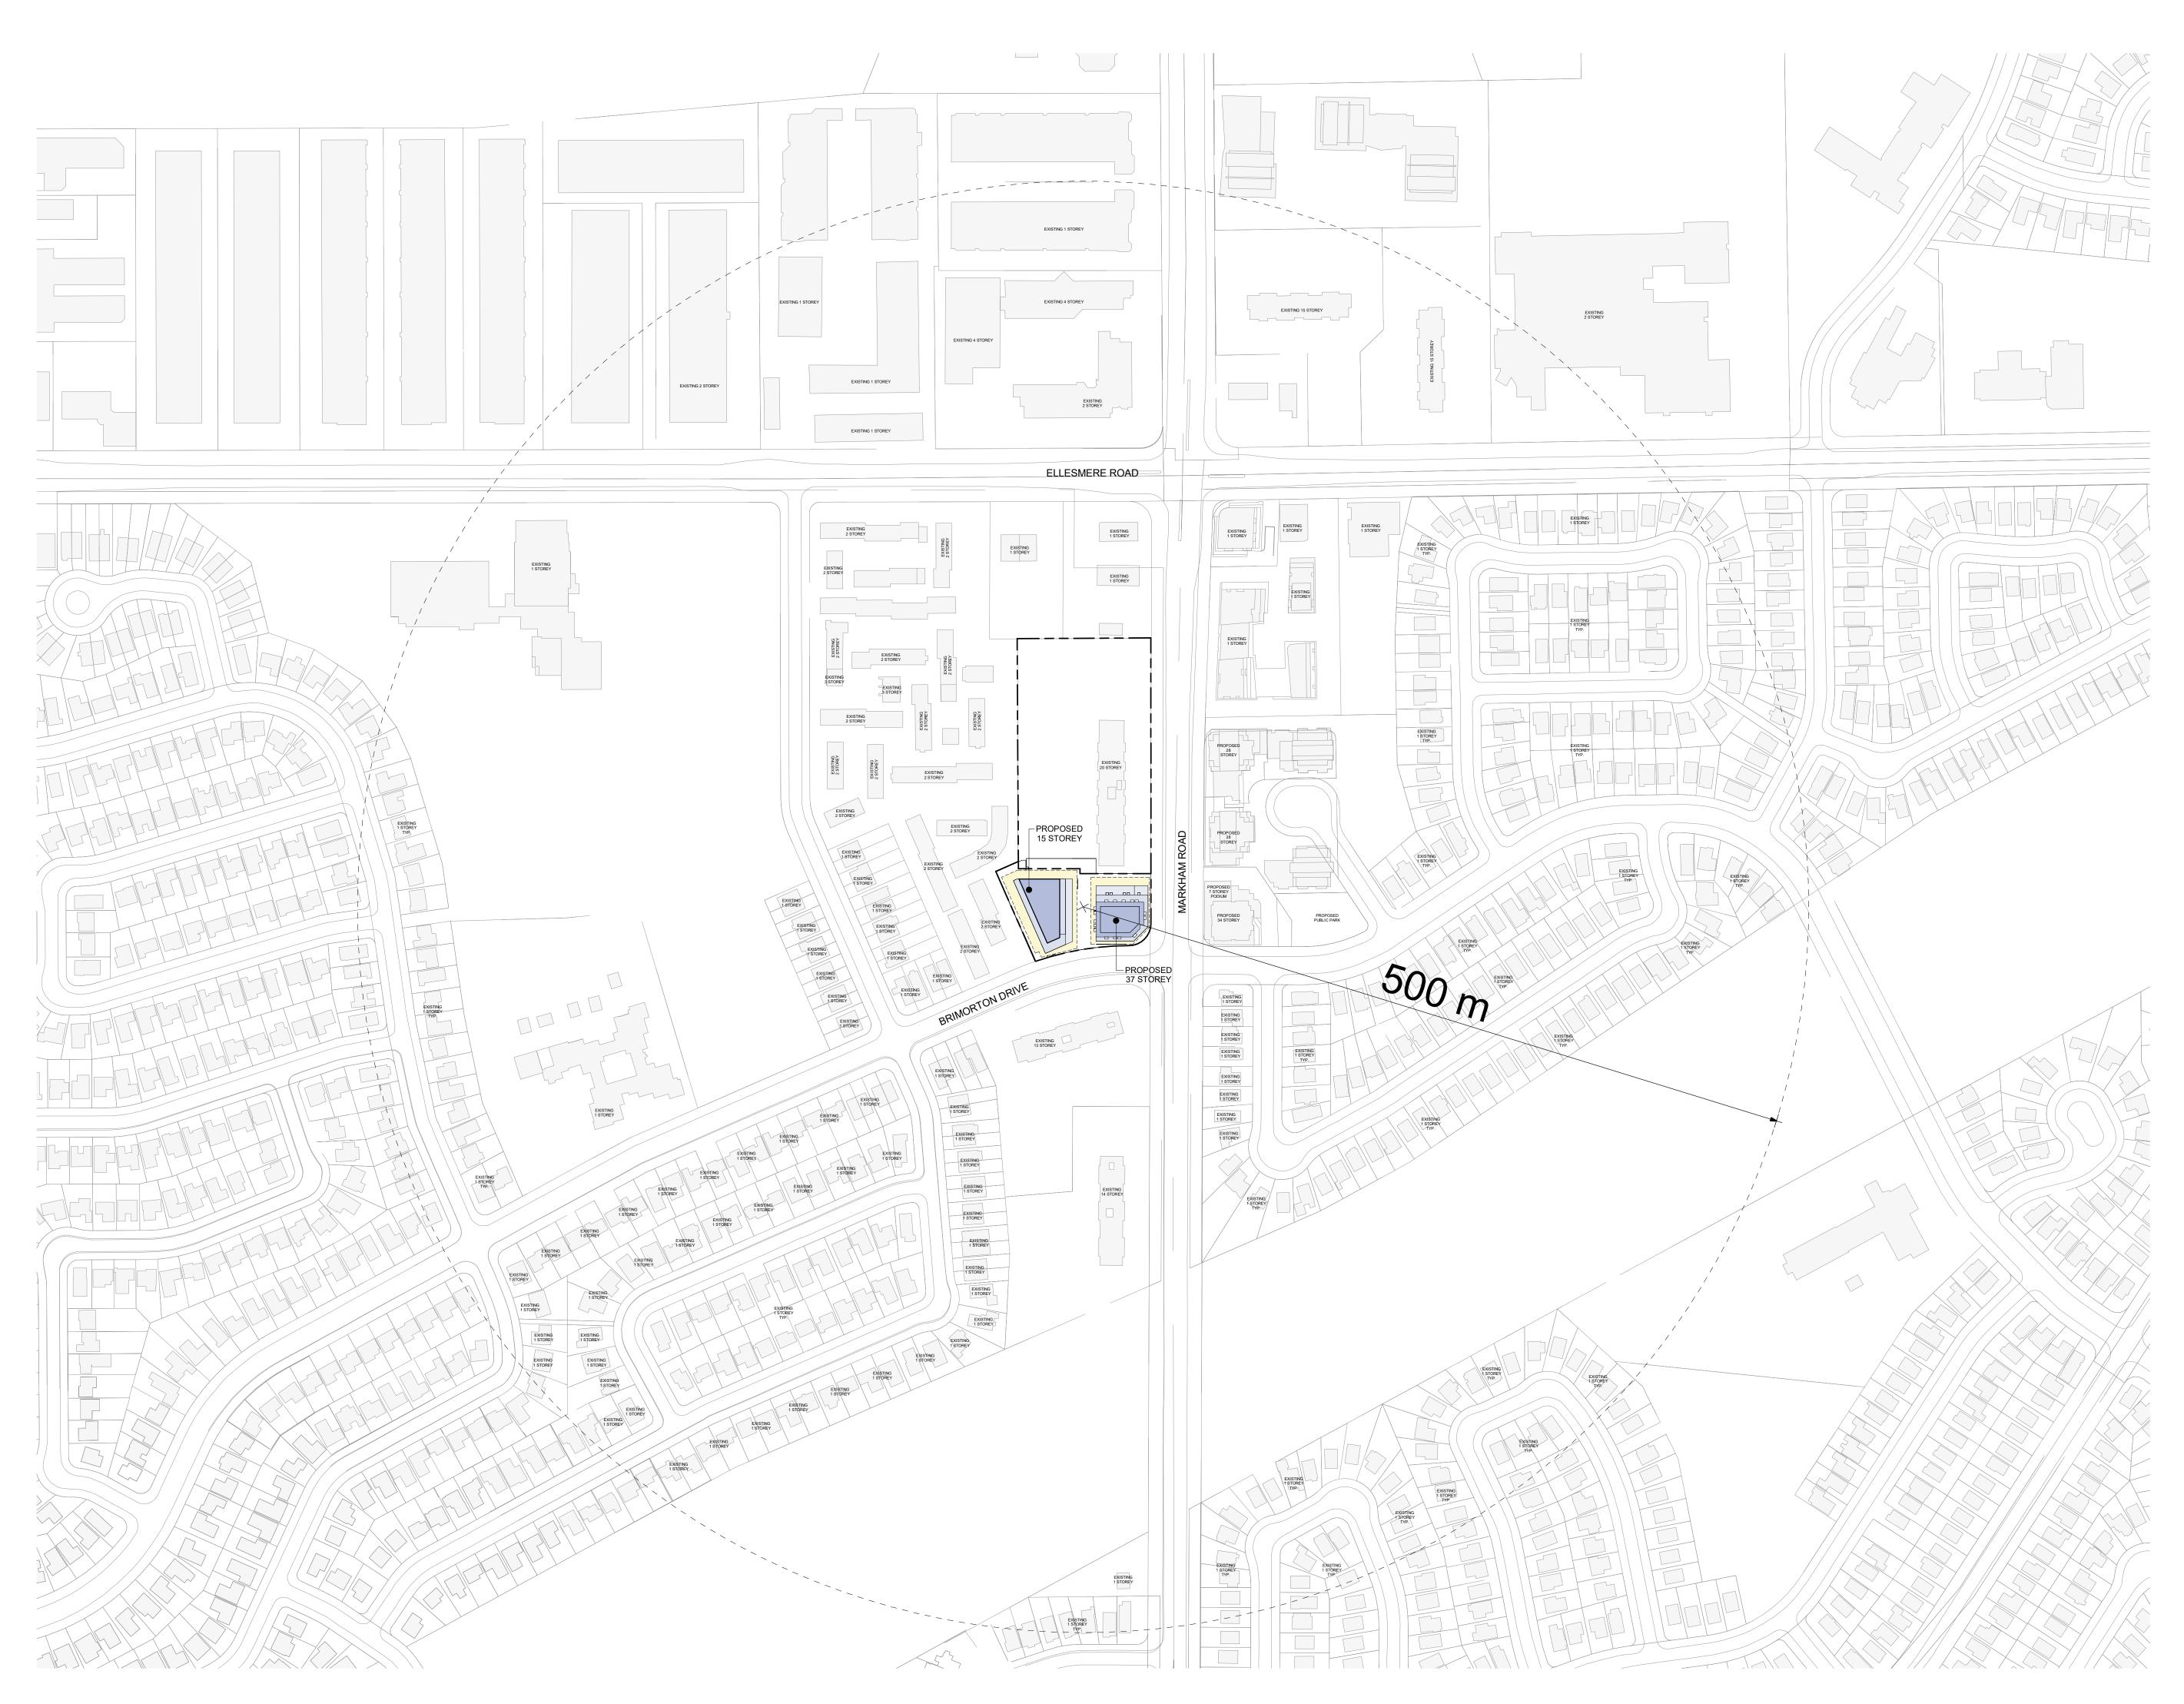

2. These Contract Documents are the property of the Architect. The Architect bears no responsibility for the interpretation of these documents by the Contractor. Upon written application the Architect will provide written/graphic clarification or supplementary information regarding the intent of the Contract Documents. The Architect will review Shop Drawings submitted by the Contractor for design conformance only.

3. Drawings are not to be scaled for construction. The Contractor is to verify all existing conditions and dimensions required to perform the work and report and discrepancies with the Contract Documents to the Architect before commencing any work.

4. Positions of exposed finishes for mechanical or electrical devised, fitting and fixtures are indicated on architectural drawings. The location shown on the architectural drawing govern over the mechanical and electrical drawings. Those items not clearly located will be located as directed by the Architect.

These drawings are not to be used for construction unless noted below as "Issued for Construction".


All work is to be carried out in conformance with the Code and Bylaws of the Authorities having jurisdiction.

7. The Architect of these plans and specifications gives no warranty or representation to any party about the constructability of the building(s) represented by them. All contractors or subcontractors must satisfy themselves when bidding and at all times ensure that they can properly construct the work represented by these plans.

No	Issued For	Date
1	Issued for ZBA	2024-06-07

WALLMANARCHITECTS

99 Spadina Avenue, Suite 600 Toronto, Ontatrio M5V 3P8 t 416 340 1870 f 416 340 1871 www.wallmanarchitects.com

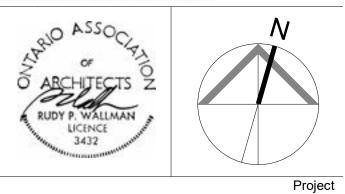

1050 Markham Road

1050 Markham Road, Toronto, Ontario, M1H 2Y5

CAPREIT


Client


Drawing Title


CONTEXT PLAN


1 : 2000	Scale
	Drawn by
	Checked by
23-11	Project No.
2024-06-07	Date
	Drawing No.


A1.04

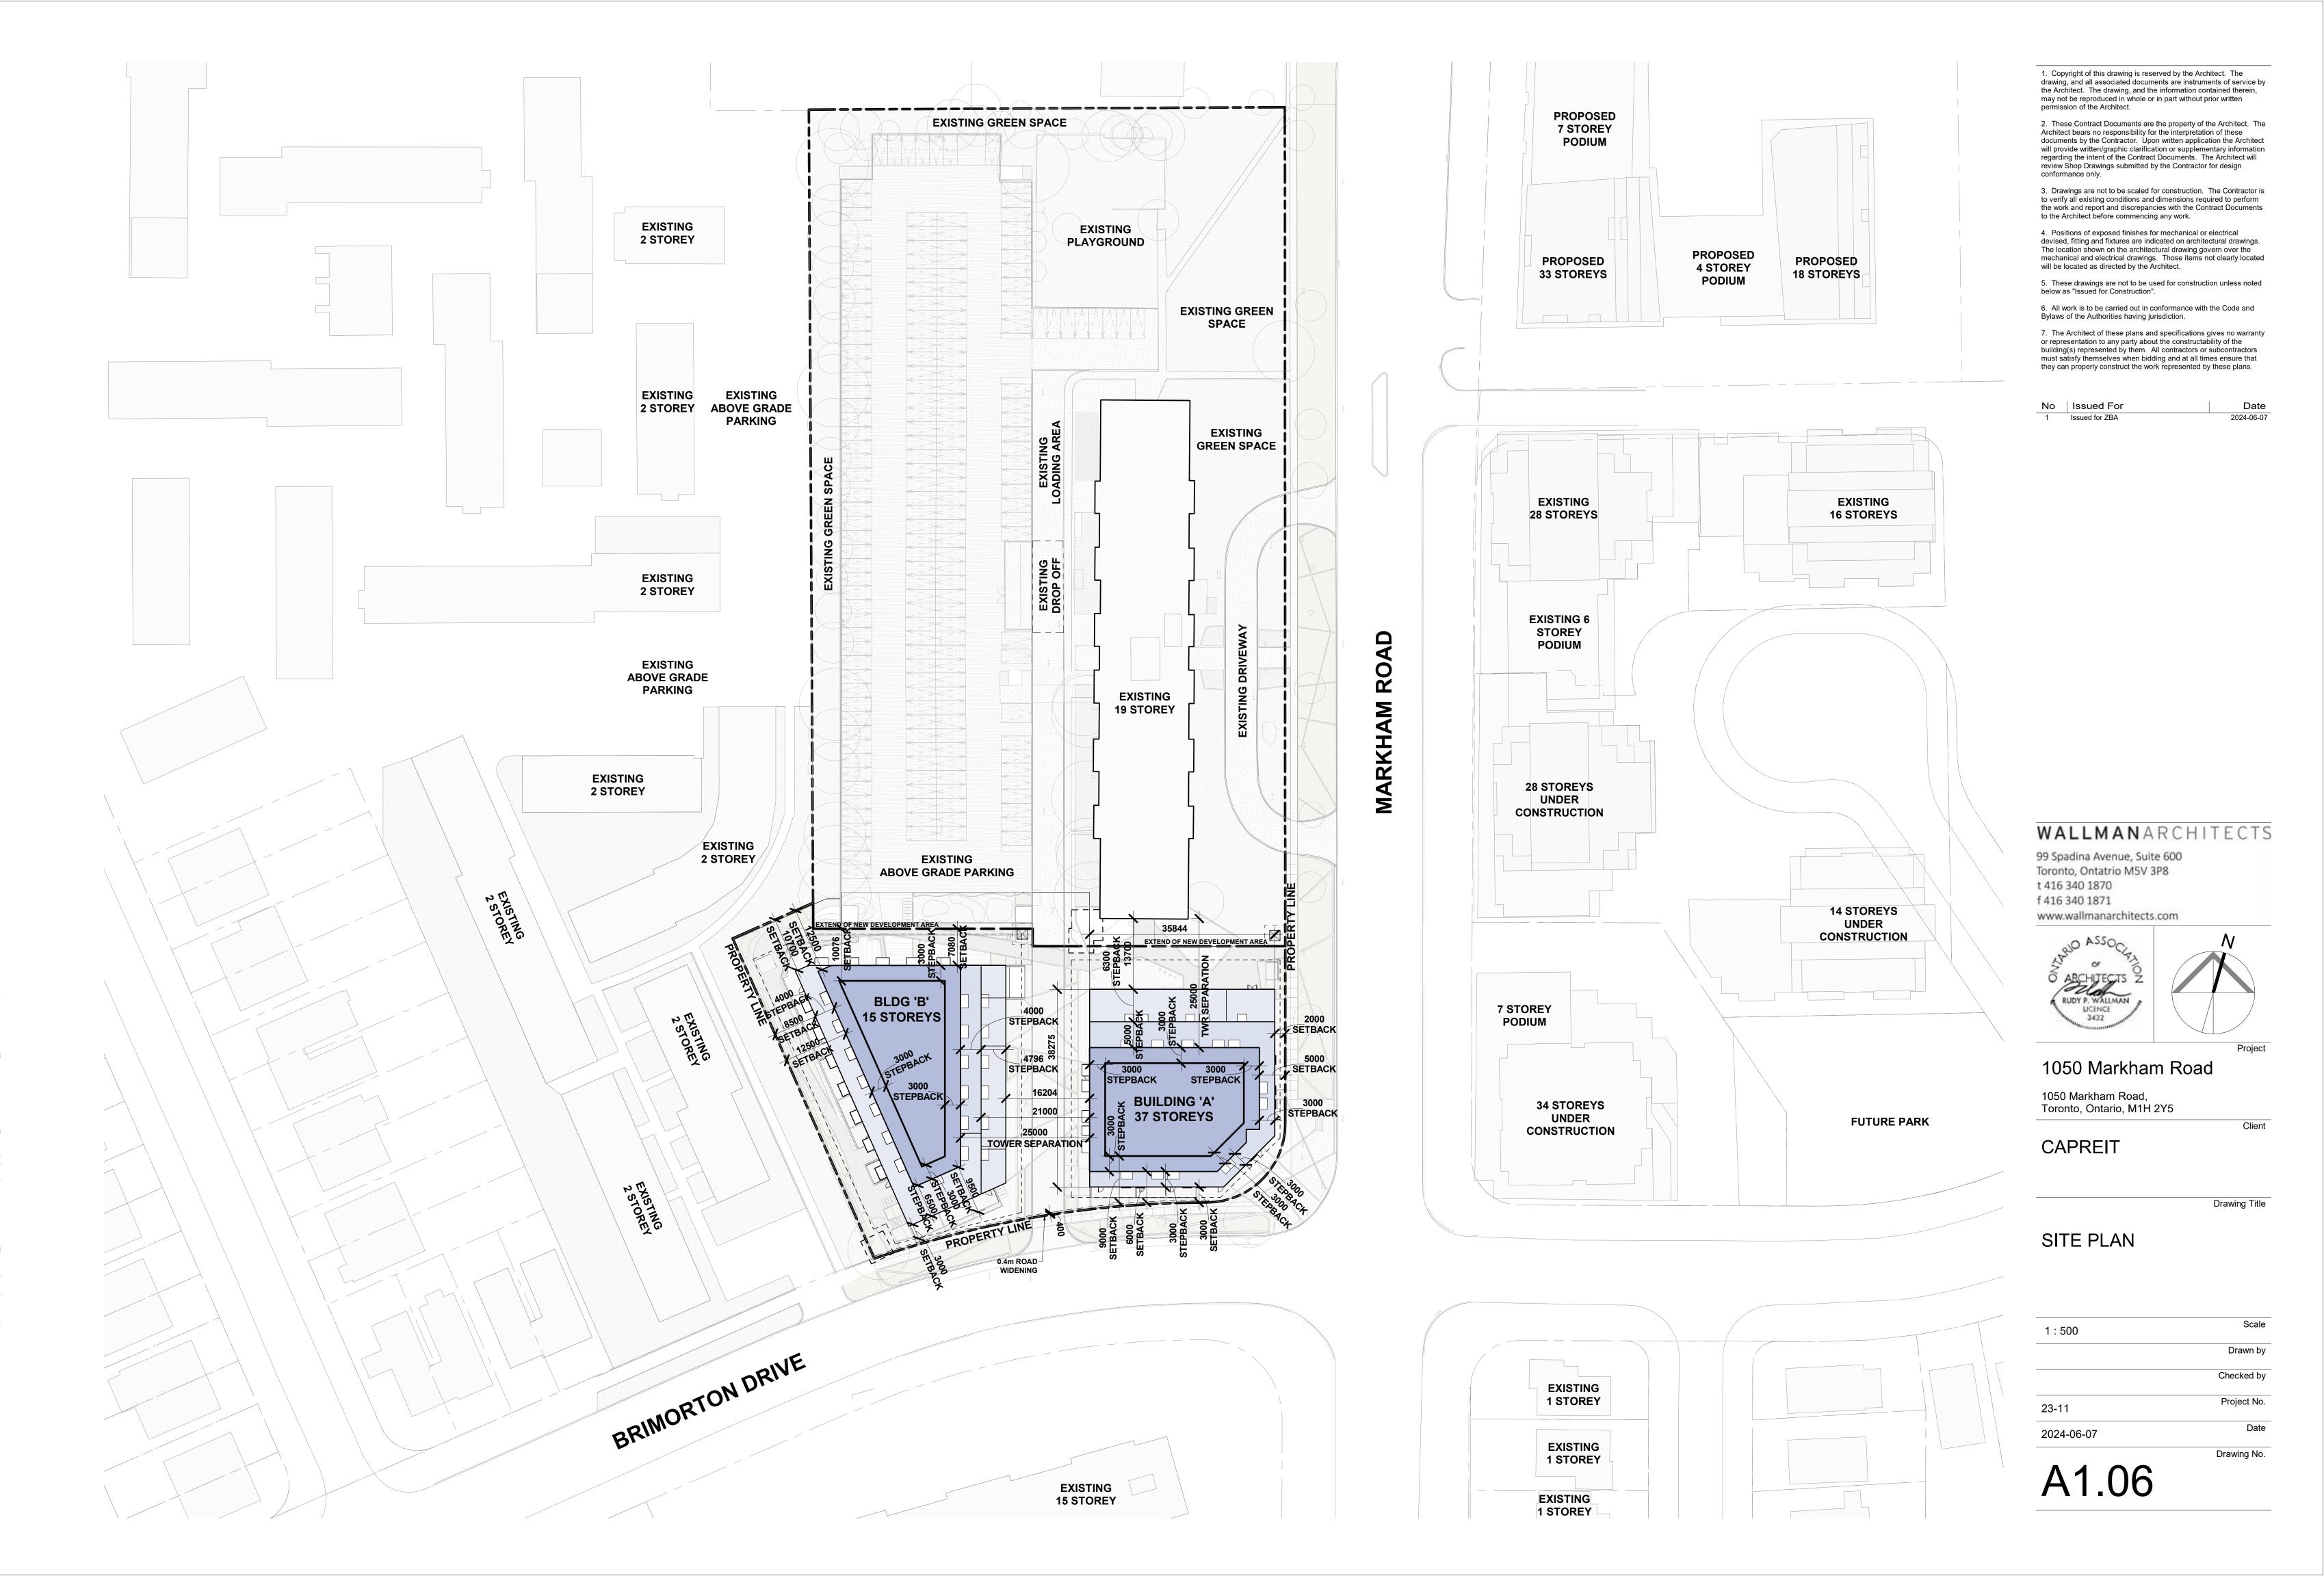

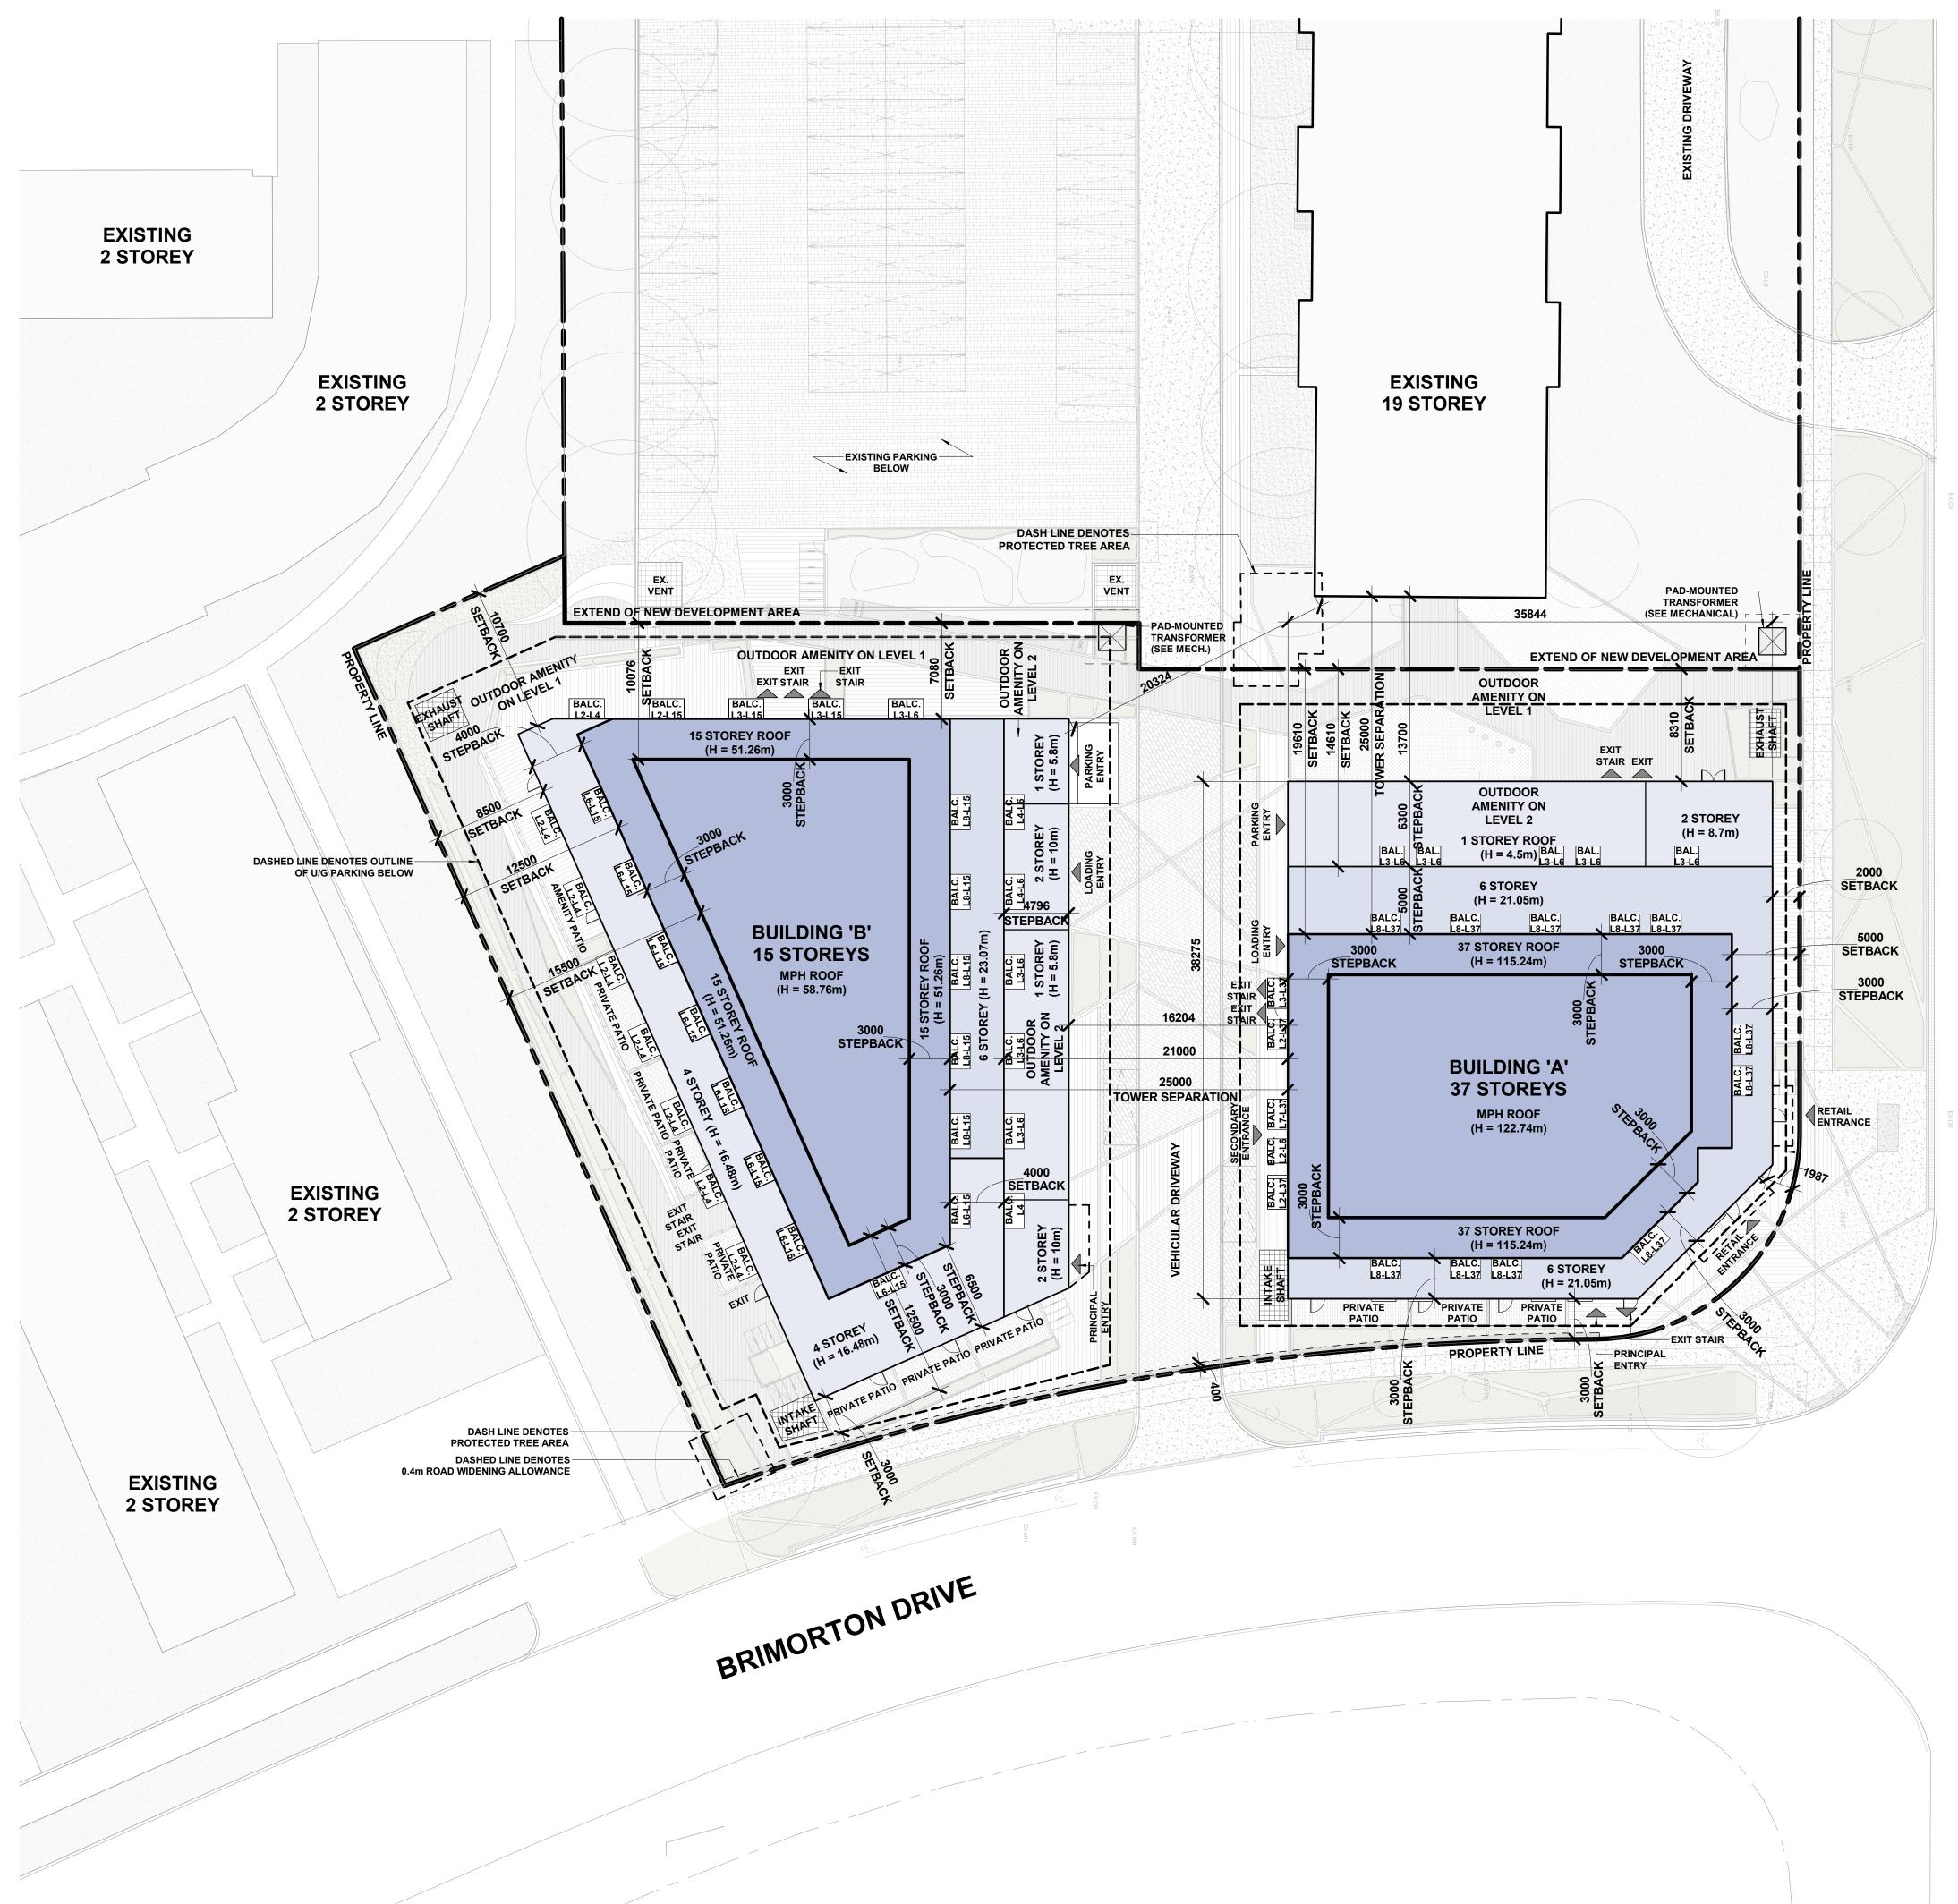

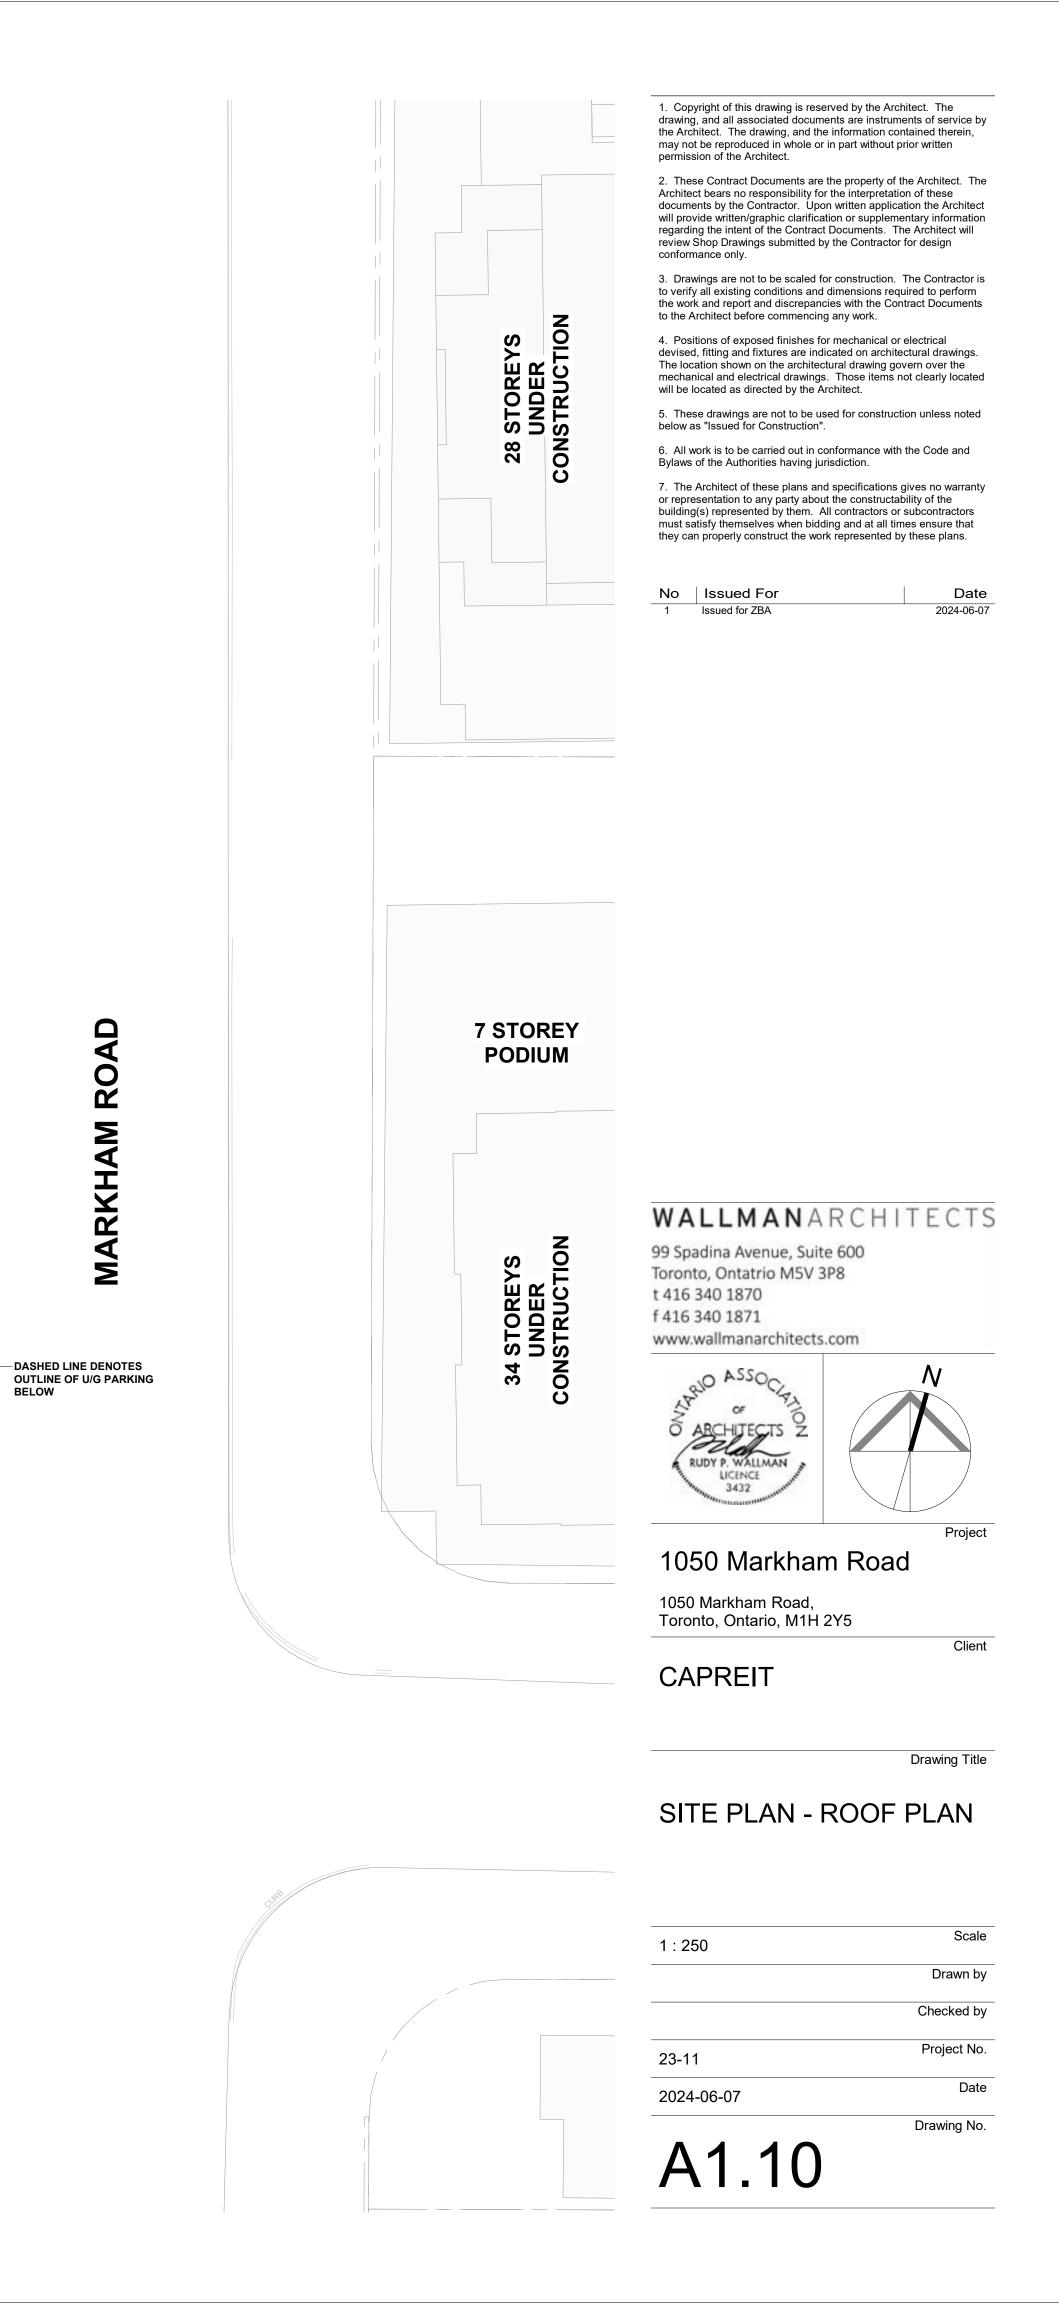

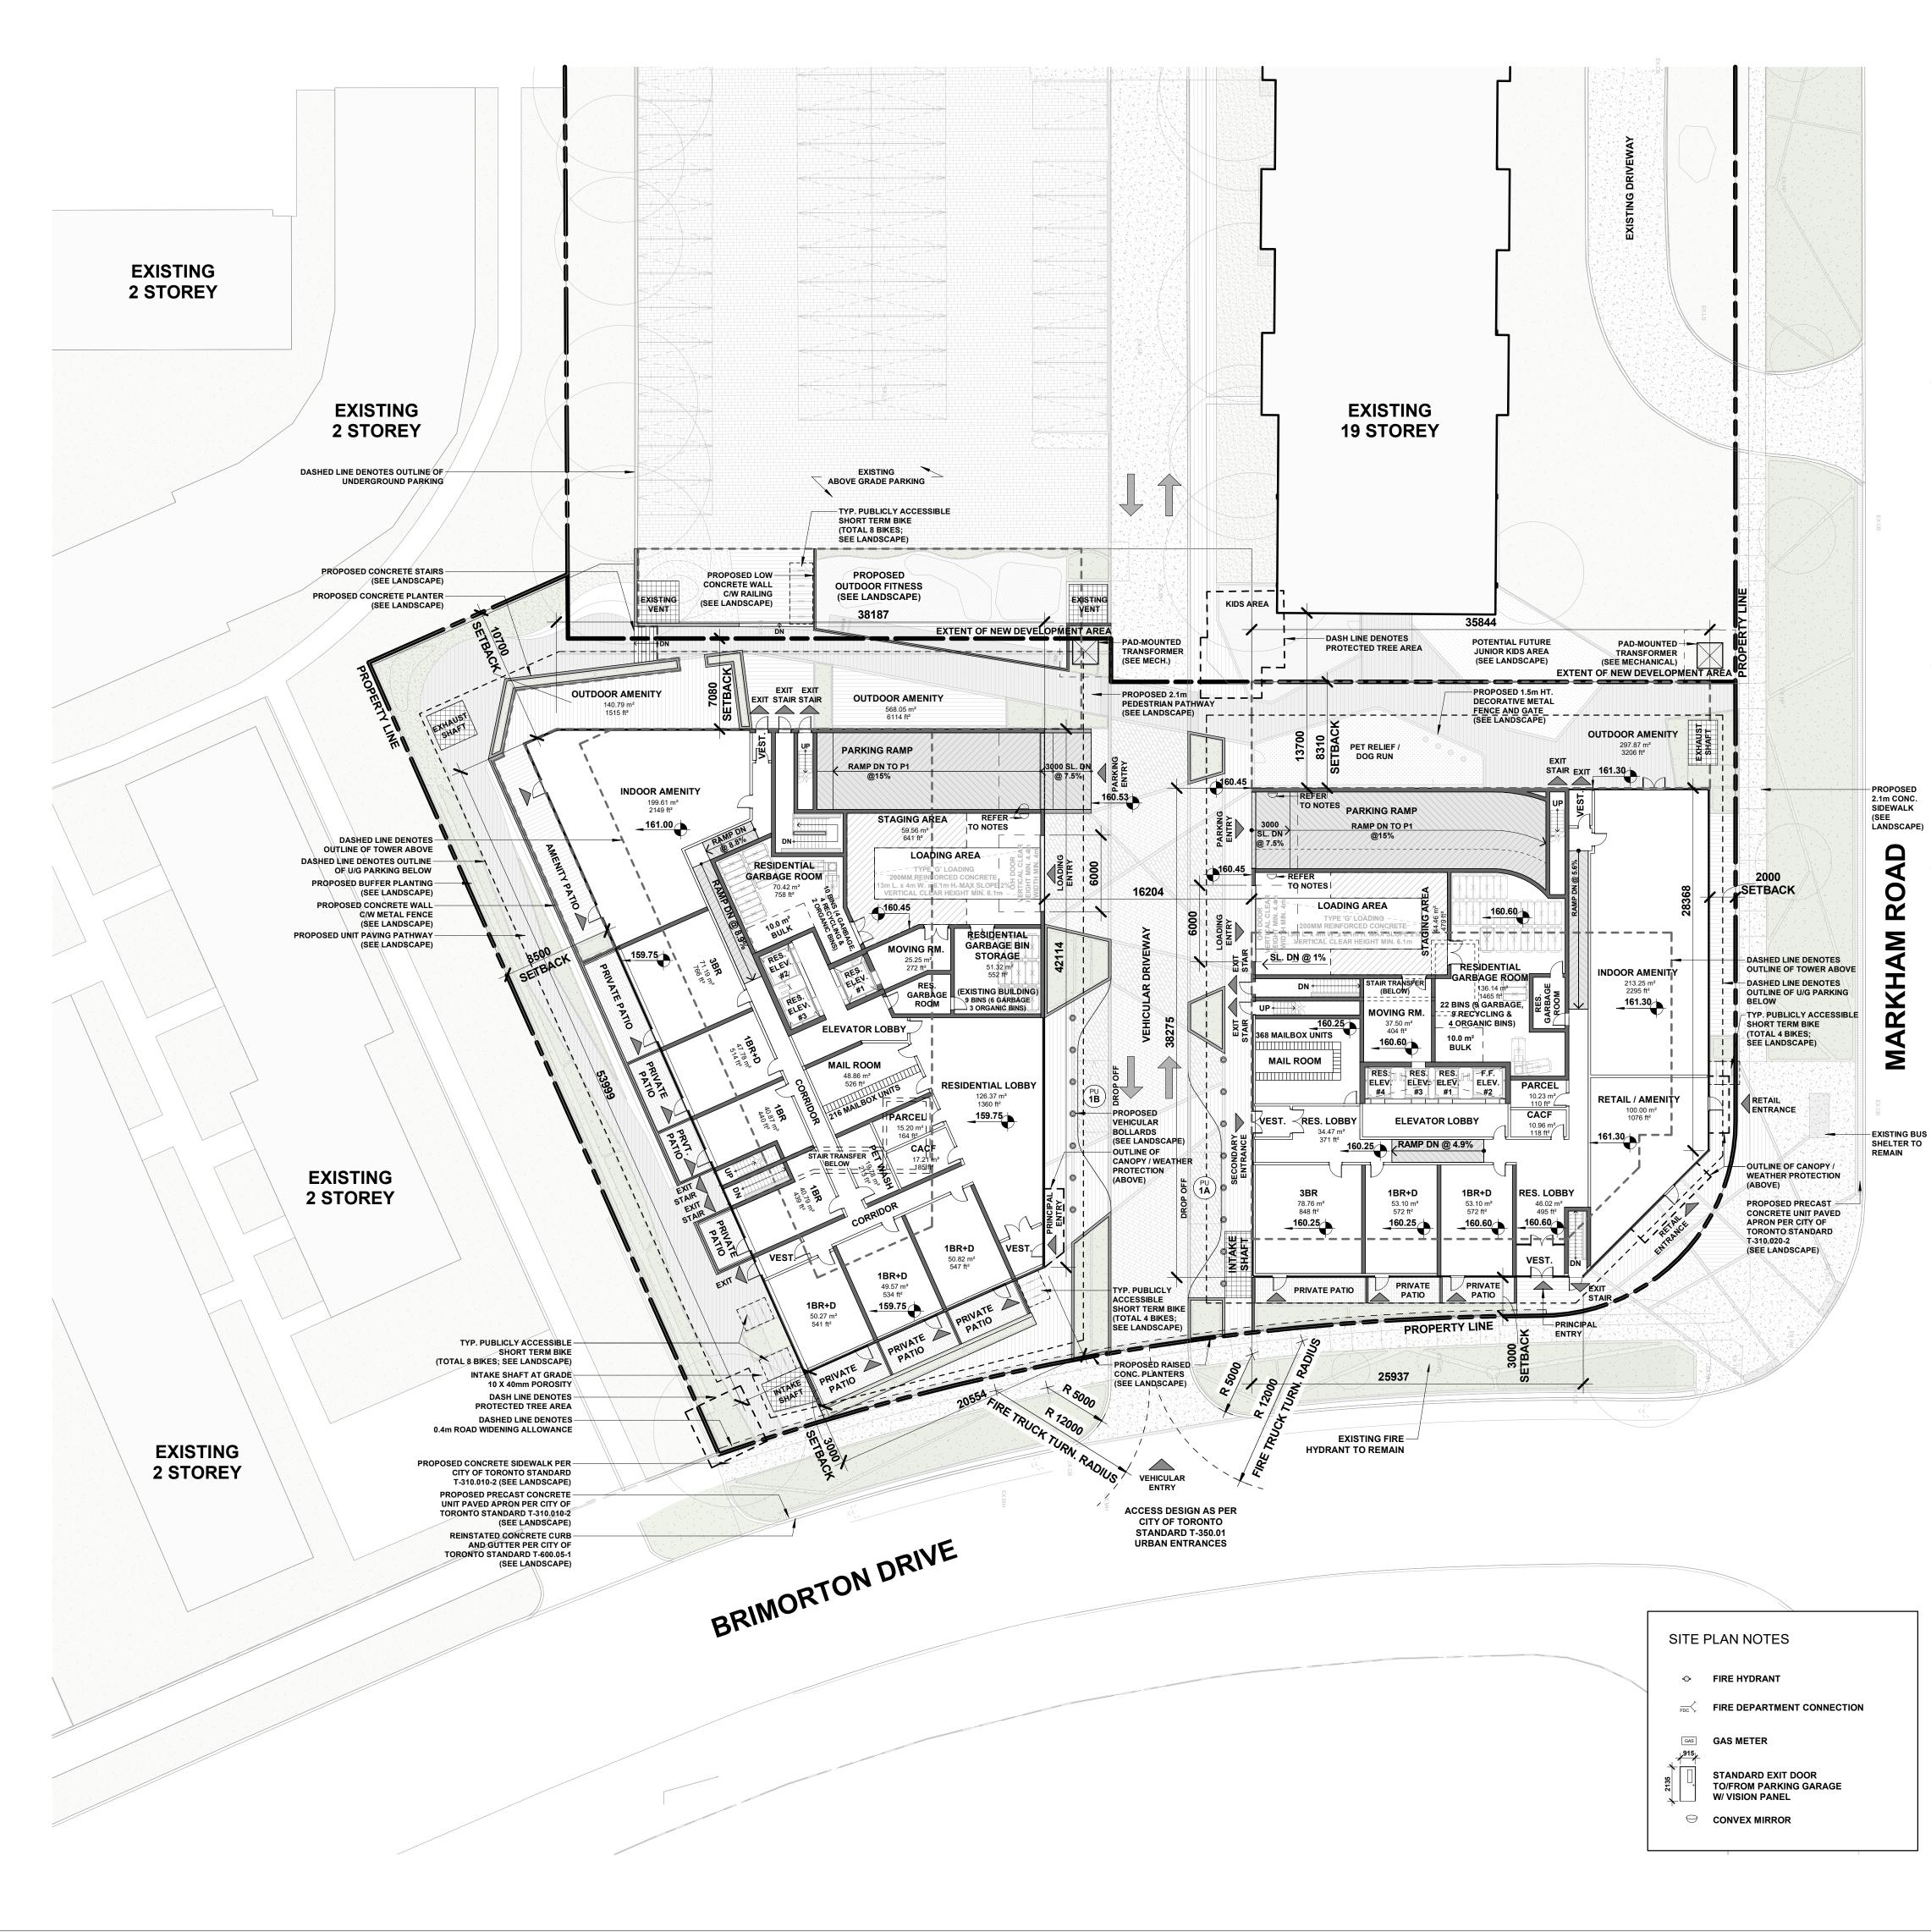

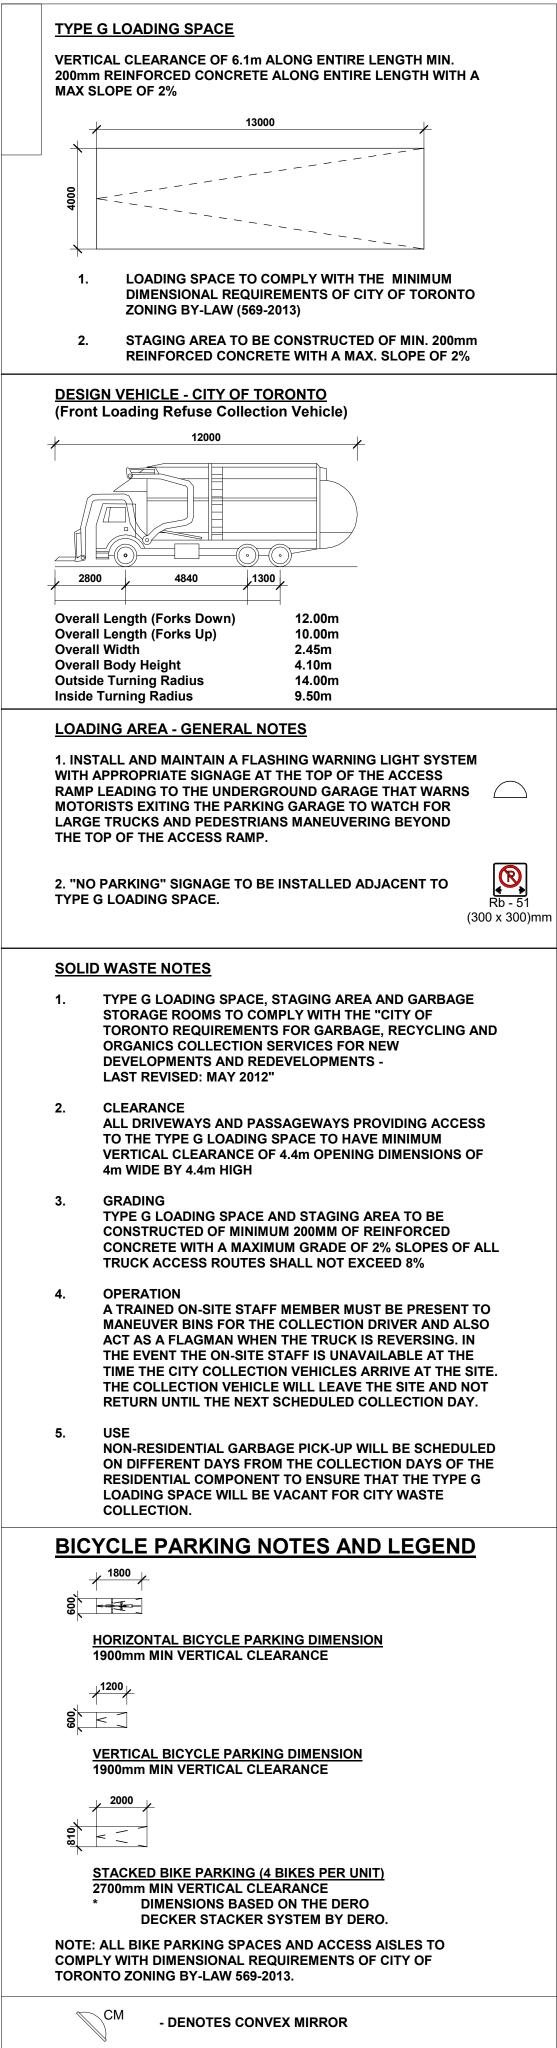

CEILING OR WALL HUNG AT A HIGH LEVEL AT ALL RIGHT-ANGLES AND AT THE TOP AND BOTTOM OF ALL RAMPS. POSITIONED TO ENSURE MOTORISTS HAVE CLEAR VIEWS OF ONCOMING TRAFFIC.

2. These Contract Documents are the property of the Architect. The Architect bears no responsibility for the interpretation of these documents by the Contractor. Upon written application the Architect will provide written/graphic clarification or supplementary information regarding the intent of the Contract Documents. The Architect will review Shop Drawings submitted by the Contractor for design conformance only.

3. Drawings are not to be scaled for construction. The Contractor is to verify all existing conditions and dimensions required to perform the work and report and discrepancies with the Contract Documents to the Architect before commencing any work.

4. Positions of exposed finishes for mechanical or electrical devised, fitting and fixtures are indicated on architectural drawings. The location shown on the architectural drawing govern over the mechanical and electrical drawings. Those items not clearly located will be located as directed by the Architect.

5. These drawings are not to be used for construction unless noted below as "Issued for Construction".

6. All work is to be carried out in conformance with the Code and Bylaws of the Authorities having jurisdiction.

7. The Architect of these plans and specifications gives no warranty or representation to any party about the constructability of the building(s) represented by them. All contractors or subcontractors must satisfy themselves when bidding and at all times ensure that they can properly construct the work represented by these plans.

No	Issued For	Date
1	Issued for ZBA	2024-06-07

WALLMANARCHITECTS

99 Spadina Avenue, Suite 600 Toronto, Ontatrio M5V 3P8 t 416 340 1870 f 416 340 1871 www.wallmanarchitects.com

ALARIO ASSOCIATIONO ARCHITECTS Z	N
	Project

1050 Markham Road

1050 Markham Road, Toronto, Ontario, M1H 2Y5

Client

CAPREIT


Drawing Title


SITE PLAN -GROUND FLOOR

A1.11

1:250	Scale
	Drawn by
	Checked by
23-11	Project No.
2024-06-07	Date

Drawing No.

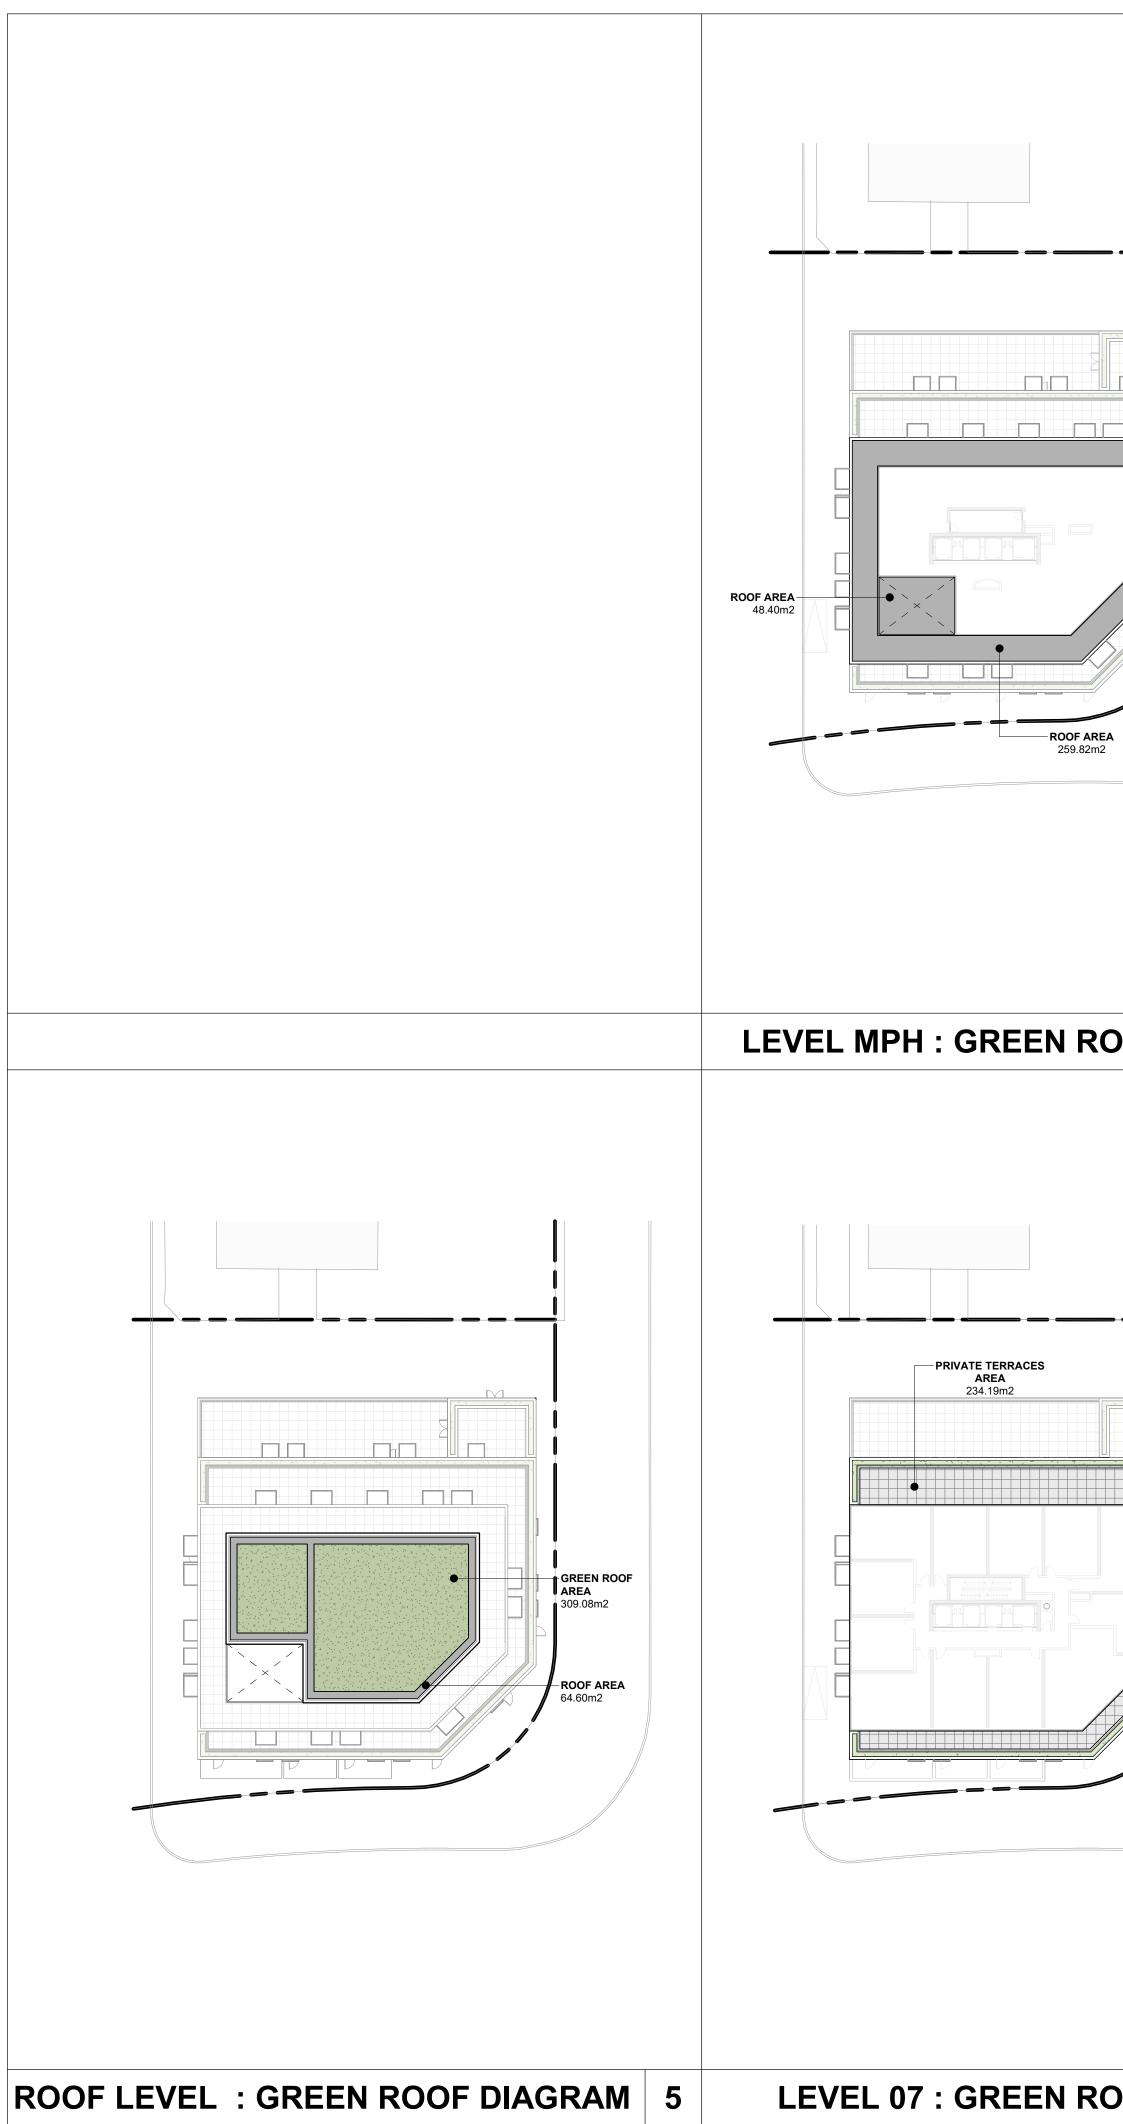

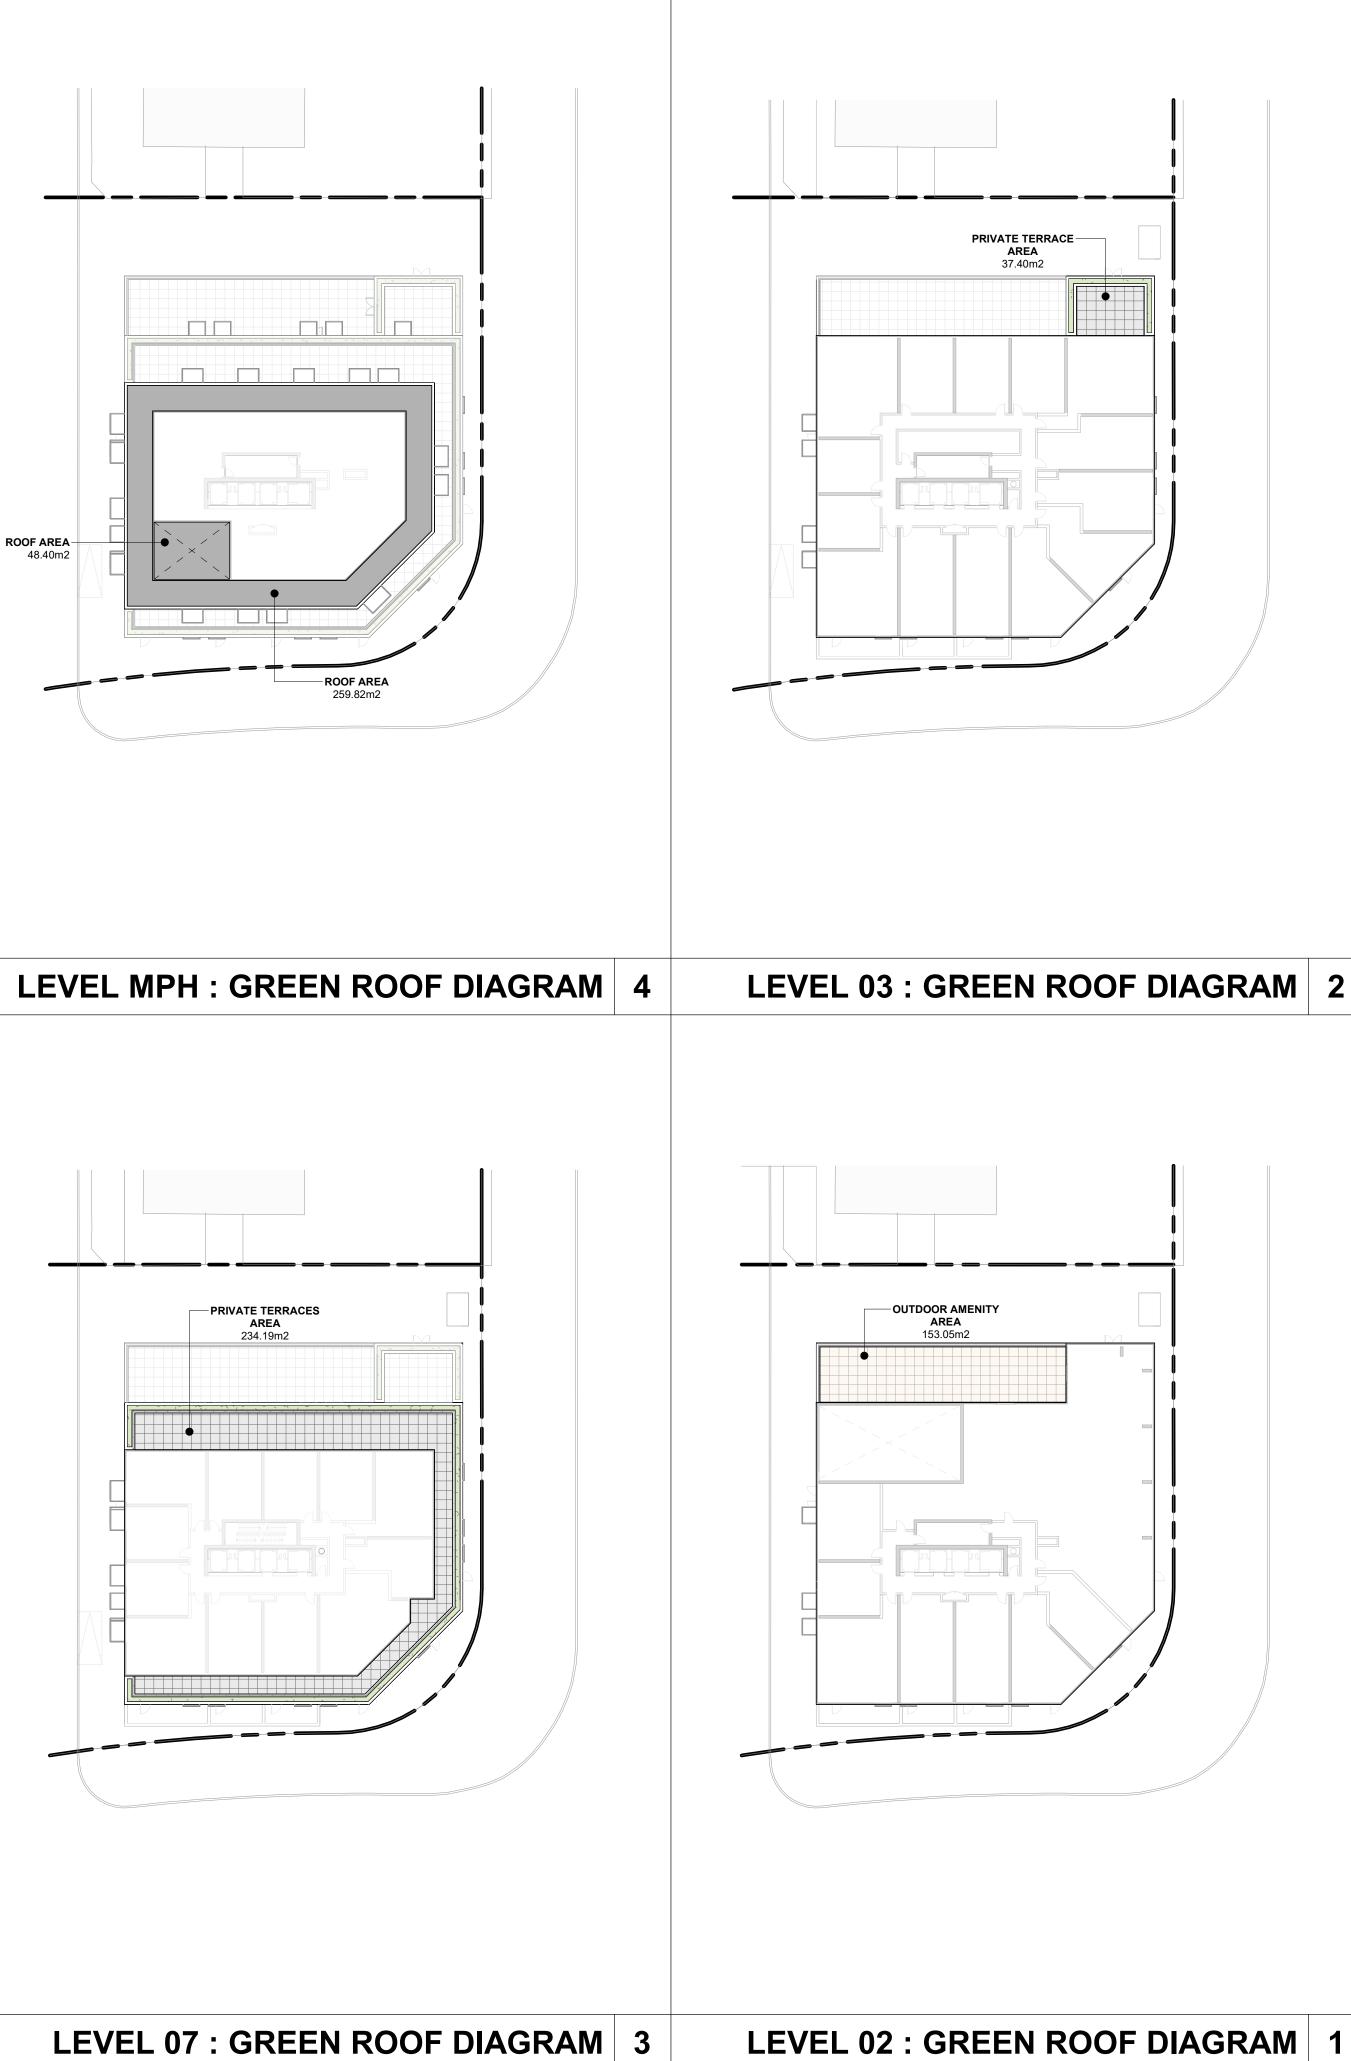

LEVEL 07 : GREEN ROOF DIAGRAM 3

TORONTO Cay Pareira Dictar

Green Roof Statistics

The Green Roof Statistics Template is required to be submitted for Site Plan Control Applications where a green roof is required under the Toronto Municipal Code Chapter 492, Green Roots. Complete the table below and copy it directly onto the Roof Plan submitted as part of any Site Plan Control Application requiring a green roof in accordance with the Bylaw. Refer to Section § 492-1 of the Municipal Code for a complete list of defined terms, and greater clarity and certainty regarding the intent and application of the terms included in the template. The Toronto Municipal Code Chapter 492, Green Roots can be found online at: http://www.toronto.col/epdocs/municode/1184_492.pdf

Green Roof Statistics

		Proposed
Gross Floor Area, as defined in Green Roof Bylaw (m ²)		36,819.1
Total Roof Area (m ²)		2,757.4
Area of Residential Private Terraces (m ²)		980.92
Rooftop Outdoor Amenity Space, if in a Residentia	al Building (m ²)	0
Area of Renewable Energy Devices (m ²)		
Tower (s)Roof Area with floor plate less than 750	π ²	· · · · · · · · · · · · · · · · · · ·
Total Available Roof Space (m ²)		0840
Green Roof Coverage	Required	Proposed
Coverage of Available Roof Space (m ²)	529.03	757.06
Coverage of Available Roof Space (%)	30%	42%

GREEN ROOF LEGEND - BUILDING A:

PRIVATE TERRACE AREA 271.59m2

ROOF AREA 259.82m2 REQUIRED ROOFTOP AMENITY SPACE PROVIDED 153.05m2 GREEN ROOF AREA 393.27m2

TOTAL ROOF AREA 1,077.73m2

1. Copyright of this drawing is reserved by the Architect. The drawing, and all associated documents are instruments of service by the Architect. The drawing, and the information contained therein, may not be reproduced in whole or in part without prior written permission of the Architect.

2. These Contract Documents are the property of the Architect. The Architect bears no responsibility for the interpretation of these documents by the Contractor. Upon written application the Architect will provide written/graphic clarification or supplementary information regarding the intent of the Contract Documents. The Architect will review Shop Drawings submitted by the Contractor for design conformance only.

3. Drawings are not to be scaled for construction. The Contractor is to verify all existing conditions and dimensions required to perform the work and report and discrepancies with the Contract Documents to the Architect before commencing any work.

4. Positions of exposed finishes for mechanical or electrical devised, fitting and fixtures are indicated on architectural drawings. The location shown on the architectural drawing govern over the mechanical and electrical drawings. Those items not clearly located will be located as directed by the Architect.

5. These drawings are not to be used for construction unless noted below as "Issued for Construction".


All work is to be carried out in conformance with the Code and Bylaws of the Authorities having jurisdiction.

7. The Architect of these plans and specifications gives no warranty or representation to any party about the constructability of the building(s) represented by them. All contractors or subcontractors must satisfy themselves when bidding and at all times ensure that they can properly construct the work represented by these plans.

No	Issued For	Date
1	Issued for ZBA	2024-06-07

WALLMANARCHITECTS

99 Spadina Avenue, Suite 600 Toronto, Ontatrio M5V 3P8 t 416 340 1870 f 416 340 1871 www.wallmanarchitects.com

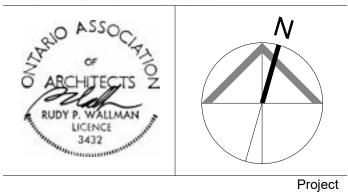

1050 Markham Road

1050 Markham Road, Toronto, Ontario, M1H 2Y5

Client

CAPREIT

A1.12


Drawing Title

Drawing No.

GREEN ROOF DIAGRAM -BUILDING A

1:400	Scale
	Drawn by
	Checked by
23-11	Project No.
2024-06-07	Date

NOTES

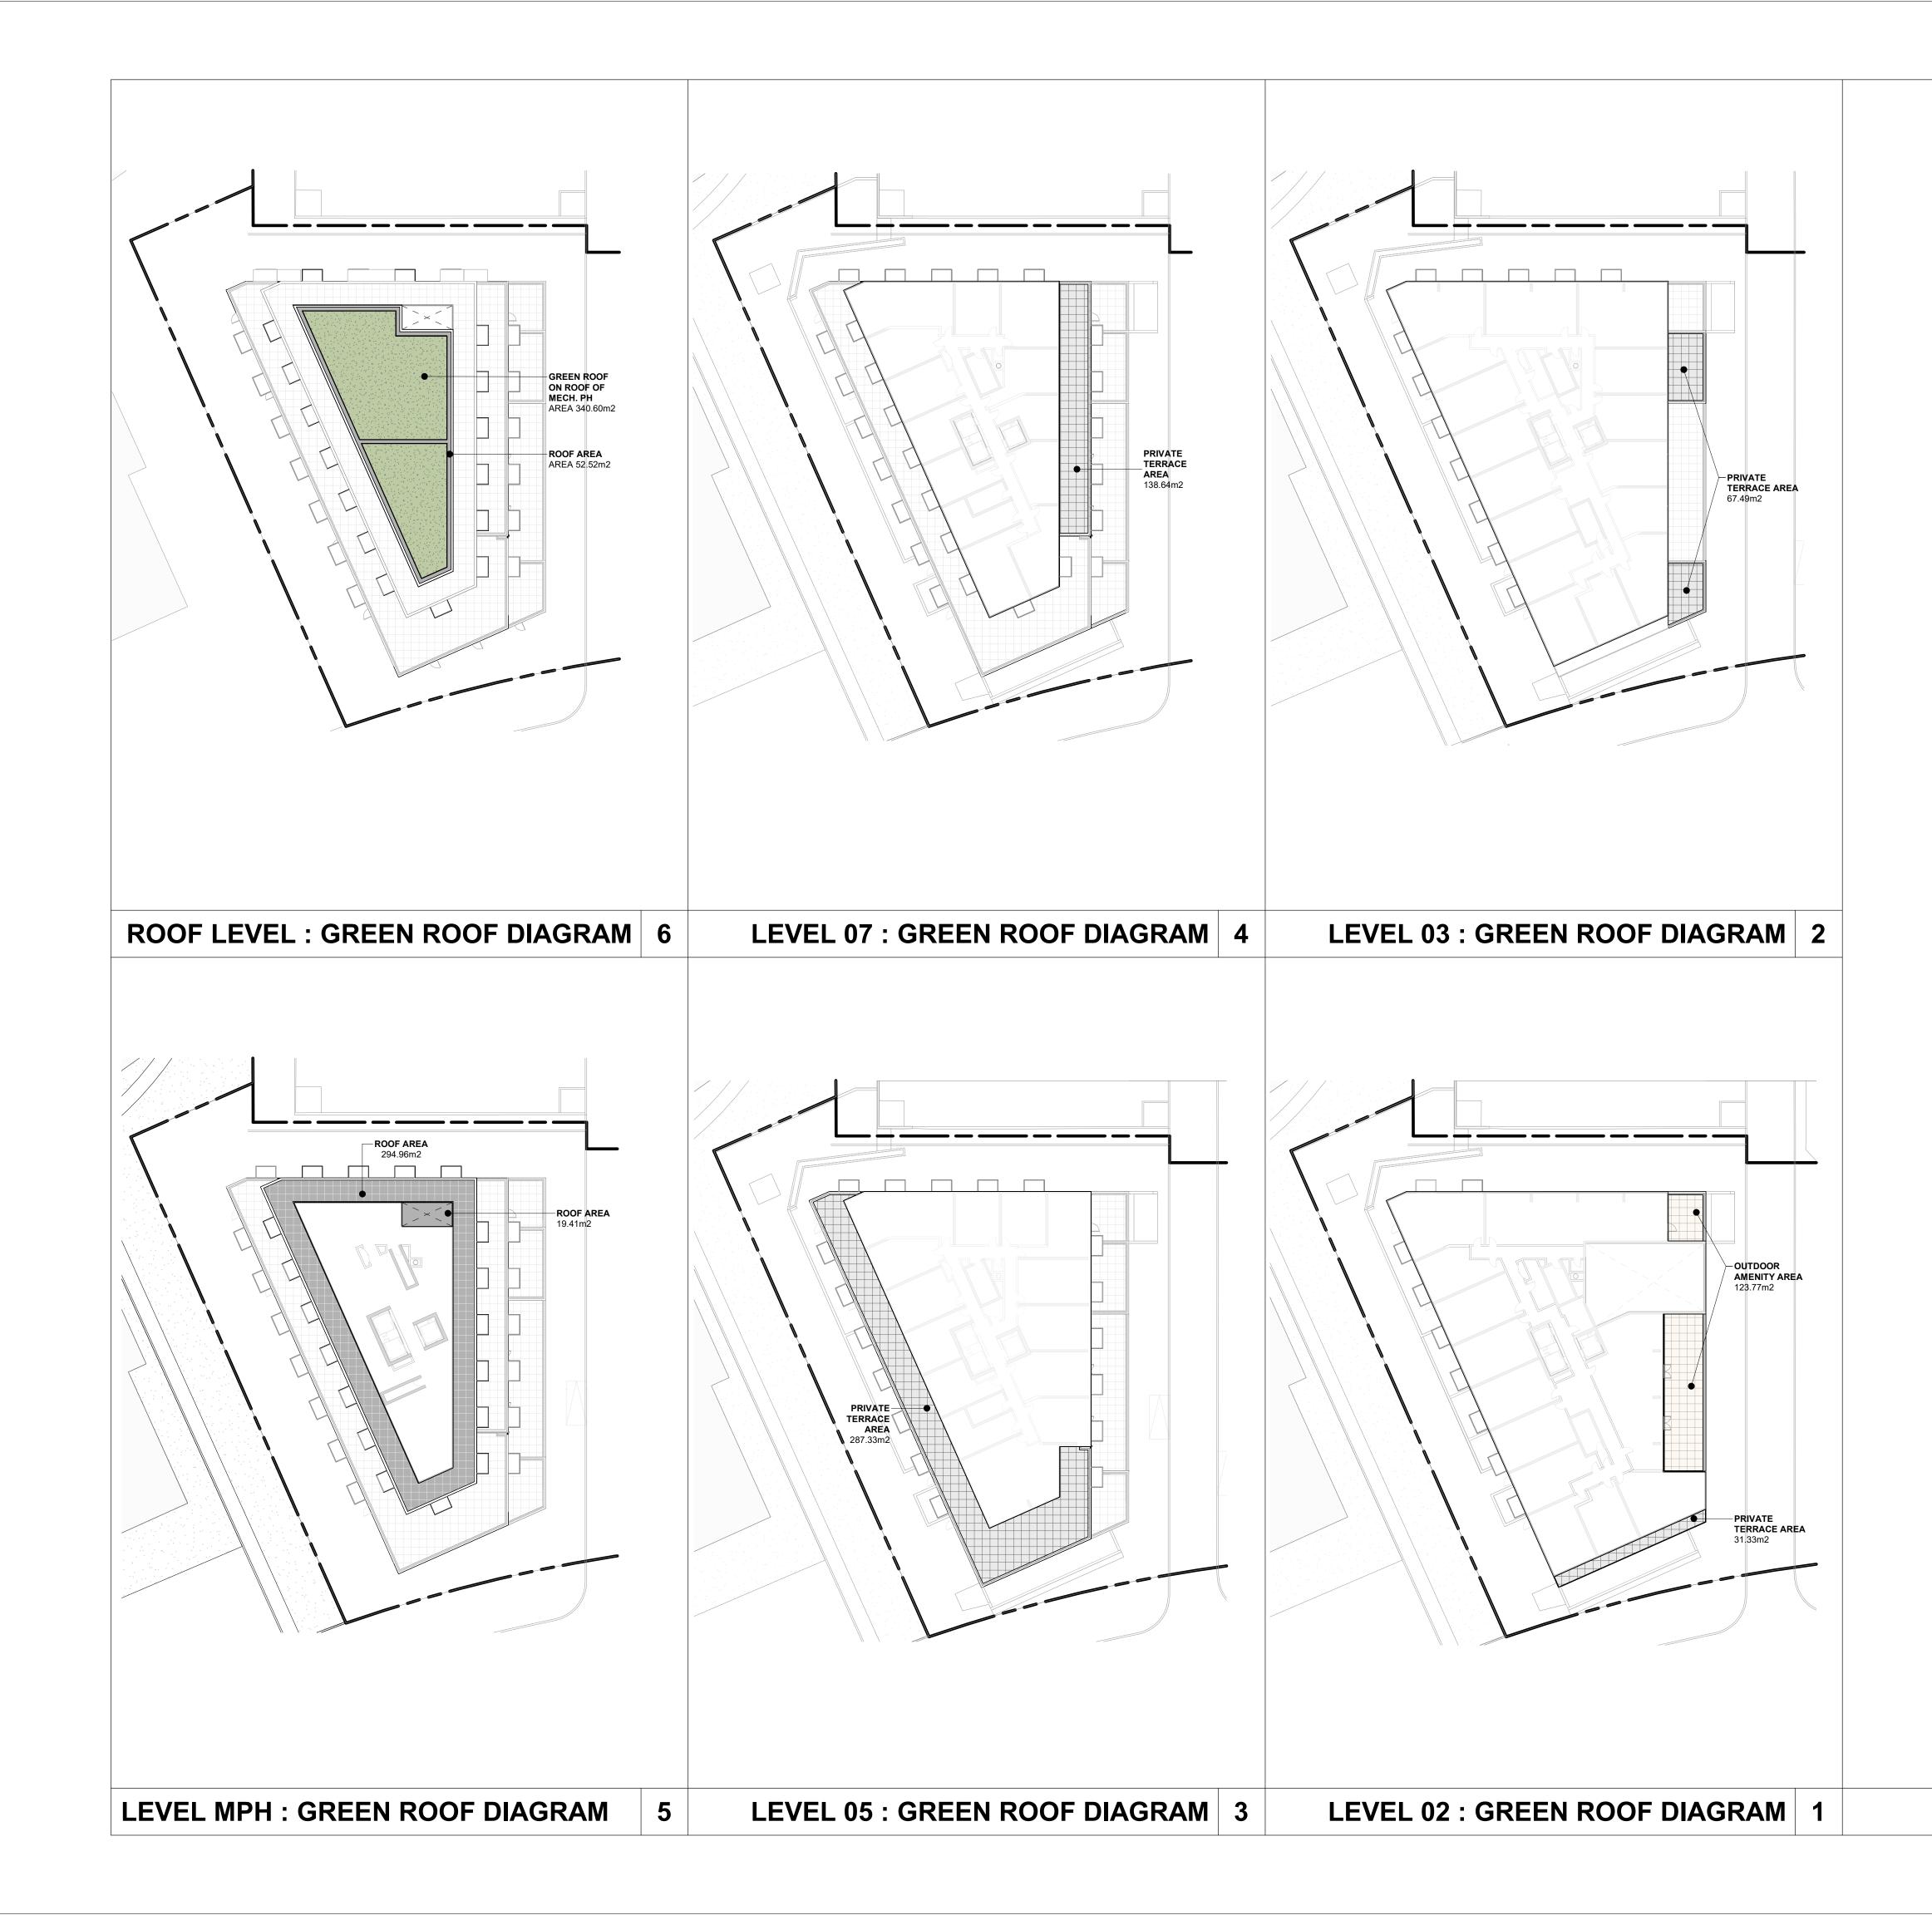

TORONTO CAN Preming Decision

Green Roof Statistics

The Green Roof Statistics Template is required to be submitted for Site Plan Control Applications where a green roof is required under the Toronto Municipal Code Chapter 492, Green Roofs. Complete the table below and **copy it directly onto the Roof Plan** submitted as part of any Site Plan Control Application requiring a green roof in accordance with the Bylaw. Refer to Section § 492-1 of the Municipal Code for a complete list of defined terms, and greater clarity and certainty regarding the intent and application of the terms included in the template. The Toronto Municipal Code Chapter 492, Green Roots can be found online at: http://www.toronto.co/legdocs/municode/1184_492.pdf

Green Roof Statistics

		Proposed
Gross Floor Area, as defined in Green Roof Bylaw (m ²)		36,819.1
Total Roof Area (m ²)		2,757.4
Area of Residential Private Terraces (m ²)		993.92
Rooftop Outdoor Amenity Space, if in a Residential Buildin	1g (m²)	0
Area of Renewable Energy Devices (m ²)		
Tower (s)Roof Area with floor plate less than 750 m ²		· · · · · · · · · · · · ·
Total Available Roof Space (m ²)	and the second second	08840
Green Roof Coverage	Required	Proposed
Coverage of Available Roof Space (m ²)	529.03	757.06
Coverage of Available Roof Space (%)	30%	42%

GREEN ROOF LEGEND - BUILDING B:

PRIVATE TERRACE AREA 524.79m2

ROOF AREA
366 89m2

REQUIRED ROOFTOP AMENITY SPACE PROVIDED 123.77m2 GREEN ROOF AREA 340.60m2

TOTAL ROOF AREA 1,356.05m2 1. Copyright of this drawing is reserved by the Architect. The drawing, and all associated documents are instruments of service by the Architect. The drawing, and the information contained therein, may not be reproduced in whole or in part without prior written permission of the Architect.

2. These Contract Documents are the property of the Architect. The Architect bears no responsibility for the interpretation of these documents by the Contractor. Upon written application the Architect will provide written/graphic clarification or supplementary information regarding the intent of the Contract Documents. The Architect will review Shop Drawings submitted by the Contractor for design conformance only.

3. Drawings are not to be scaled for construction. The Contractor is to verify all existing conditions and dimensions required to perform the work and report and discrepancies with the Contract Documents to the Architect before commencing any work.

4. Positions of exposed finishes for mechanical or electrical devised, fitting and fixtures are indicated on architectural drawings. The location shown on the architectural drawing govern over the mechanical and electrical drawings. Those items not clearly located will be located as directed by the Architect.

5. These drawings are not to be used for construction unless noted below as "Issued for Construction".


6. All work is to be carried out in conformance with the Code and Bylaws of the Authorities having jurisdiction.

7. The Architect of these plans and specifications gives no warranty or representation to any party about the constructability of the building(s) represented by them. All contractors or subcontractors must satisfy themselves when bidding and at all times ensure that they can properly construct the work represented by these plans.

No	Issued For	Date
1	Issued for ZBA	2024-06-07

WALLMANARCHITECTS

99 Spadina Avenue, Suite 600 Toronto, Ontatrio M5V 3P8 t 416 340 1870 f 416 340 1871 www.wallmanarchitects.com

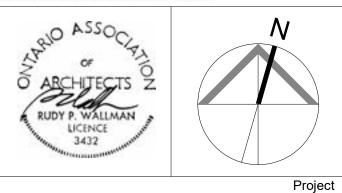

1050 Markham Road

1050 Markham Road, Toronto, Ontario, M1H 2Y5

Client

CAPREIT

Drawing Title


Drawing No.


GREEN ROOF DIAGRAM -BUILDING B


1:400	Scale
	Drawn by
	Checked by
23-11	Project No.
2024-06-07	Date


A1.13

NOTES

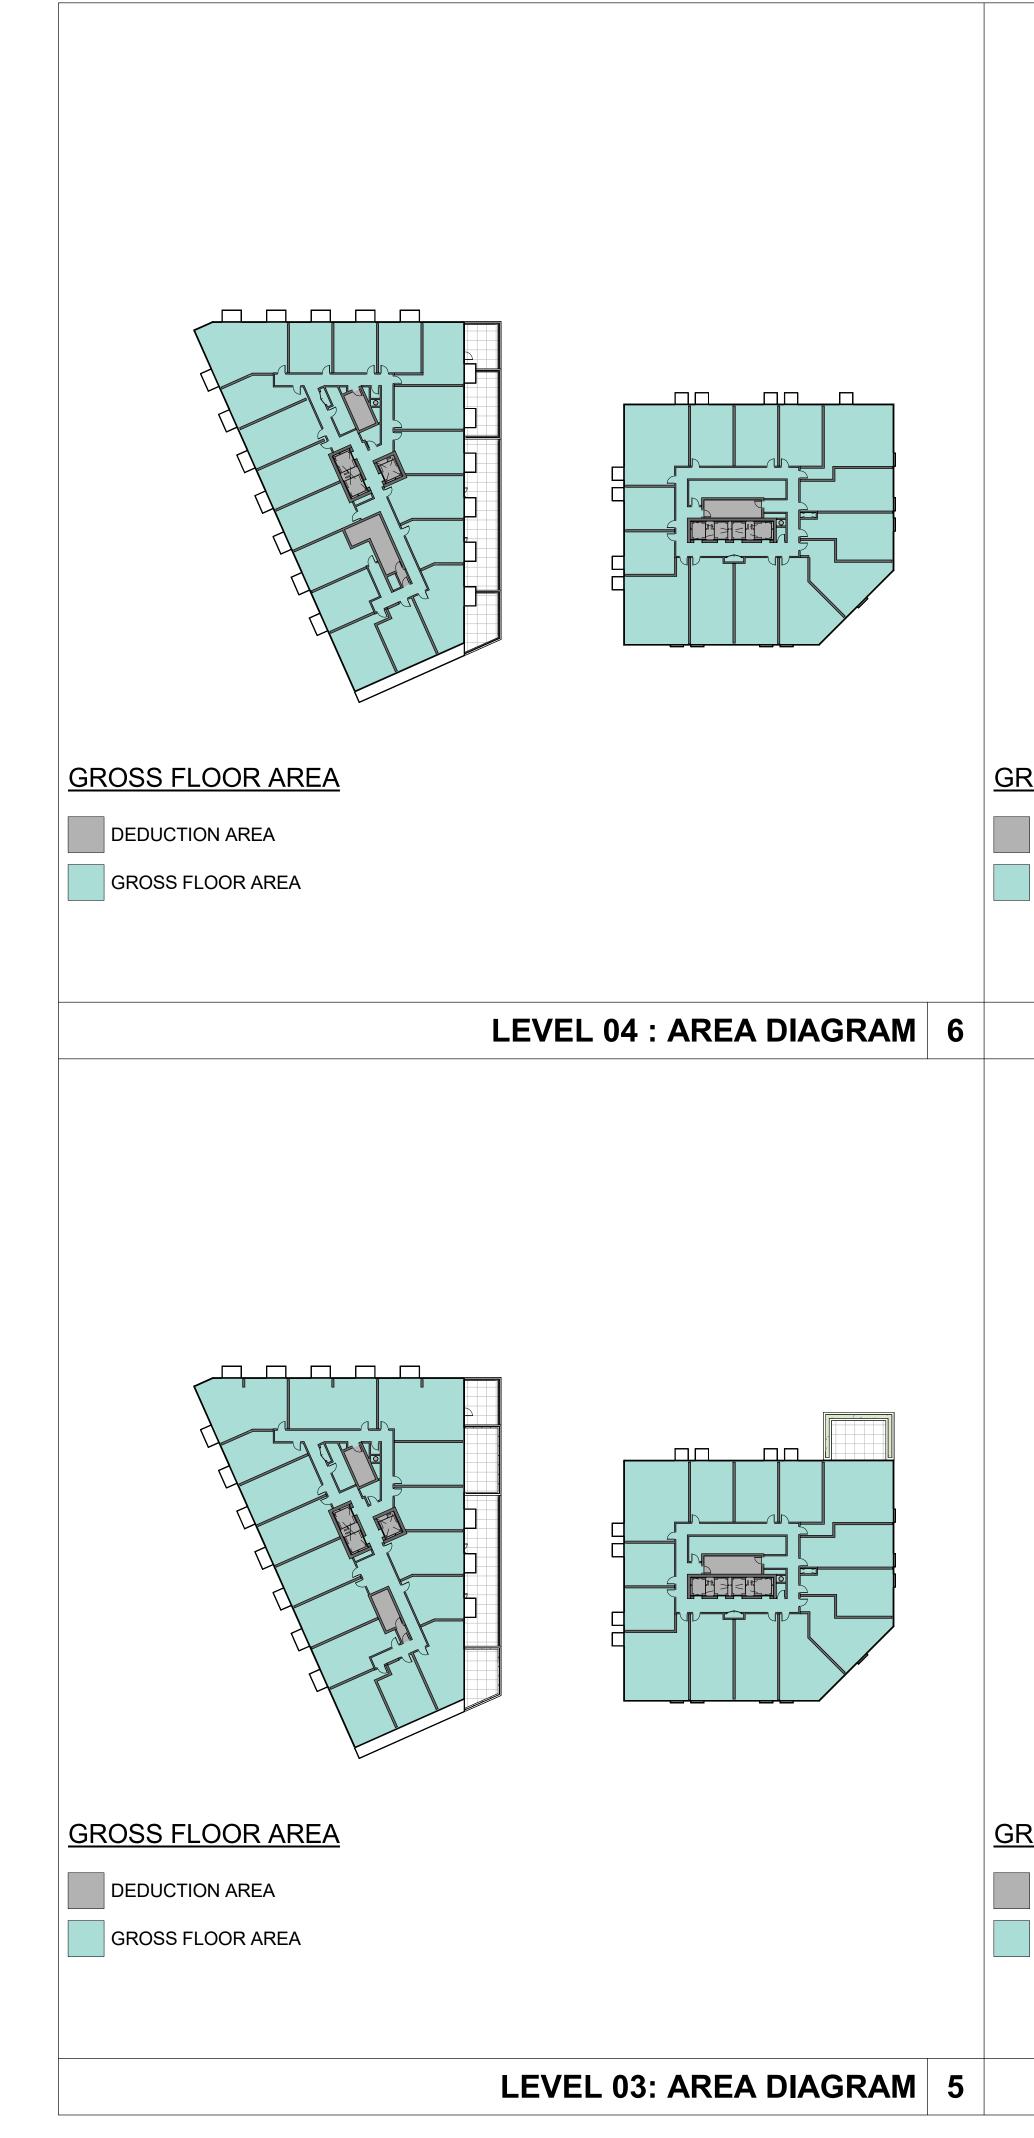

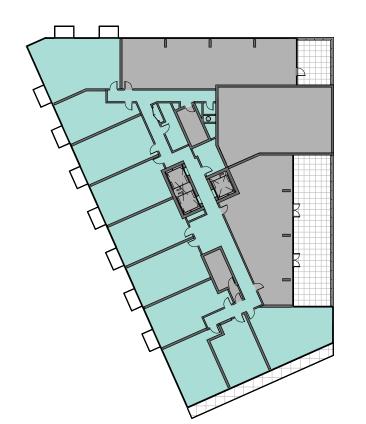

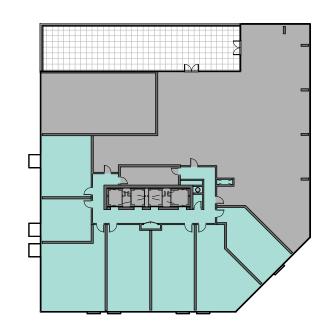

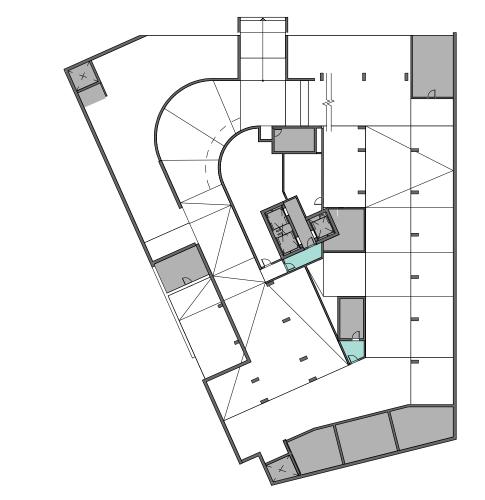

GROSS FLOOR AREA


DEDUCTION AREA GROSS FLOOR AREA

GROSS FLOOR AREA

DEDUCTION AREA

GROSS FLOOR AREA


LEVEL 02 : AREA DIAGRAM 4

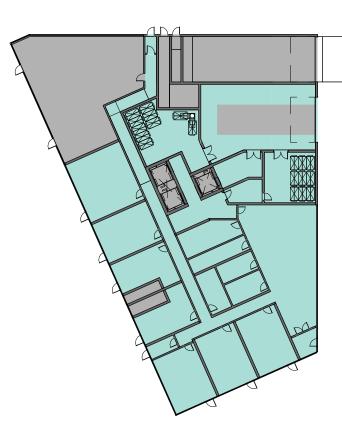

GROSS FLOOR AREA

DEDUCTION AREA


GROSS FLOOR AREA

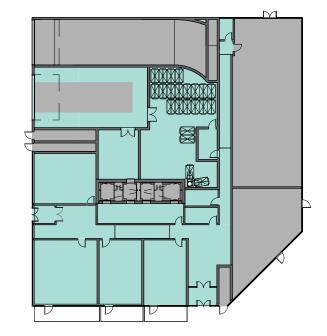




DEDUCTION AREA

GROSS FLOOR AREA

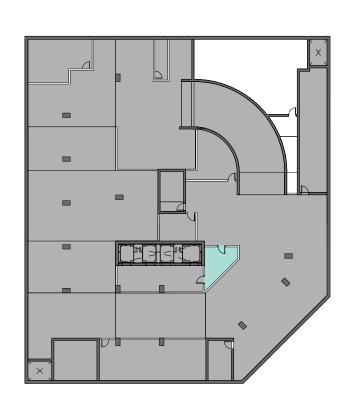

LEVEL P1 : AREA DIAGRAM 2

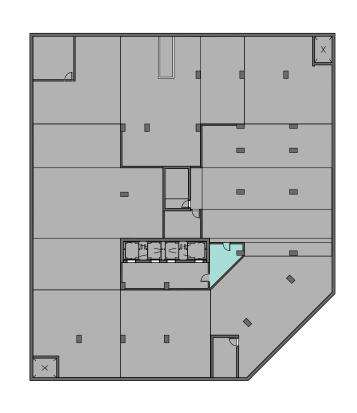

1. Copyright of this drawing is reserved by the Architect. The drawing, and all associated documents are instruments of service by the Architect. The drawing, and the information contained therein, may not be reproduced in whole or in part without prior written permission of the Architect.

2. These Contract Documents are the property of the Architect. The Architect bears no responsibility for the interpretation of these documents by the Contractor. Upon written application the Architect will provide written/graphic clarification or supplementary information regarding the intent of the Contract Documents. The Architect will review Shop Drawings submitted by the Contractor for design conformance only.

3. Drawings are not to be scaled for construction. The Contractor is to verify all existing conditions and dimensions required to perform the work and report and discrepancies with the Contract Documents to the Architect before commencing any work.

4. Positions of exposed finishes for mechanical or electrical devised, fitting and fixtures are indicated on architectural drawings. The location shown on the architectural drawing govern over the mechanical and electrical drawings. Those items not clearly located will be located as directed by the Architect.

5. These drawings are not to be used for construction unless noted below as "Issued for Construction".


6. All work is to be carried out in conformance with the Code and Bylaws of the Authorities having jurisdiction.

7. The Architect of these plans and specifications gives no warranty or representation to any party about the constructability of the building(s) represented by them. All contractors or subcontractors must satisfy themselves when bidding and at all times ensure that they can properly construct the work represented by these plans.

No	Issued For	Date
1	Issued for ZBA	2024-06-07

WALLMANARCHITECTS

99 Spadina Avenue, Suite 600 Toronto, Ontatrio M5V 3P8 t 416 340 1870 f 416 340 1871 www.wallmanarchitects.com

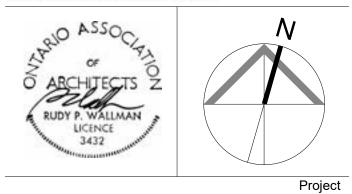

1050 Markham Road

1050 Markham Road, Toronto, Ontario, M1H 2Y5

Client

CAPREIT

Drawing Title

Drawing No.

AREA DIAGRAMS


1 : 500	Scale
	Drawn by
	Checked by
23-11	Project No.
2024-06-07	Date


LEVEL P2 : AREA DIAGRAM 1

A1.20

MECHANCIAL PENTHOUSE : AREA DIAGRAM 5




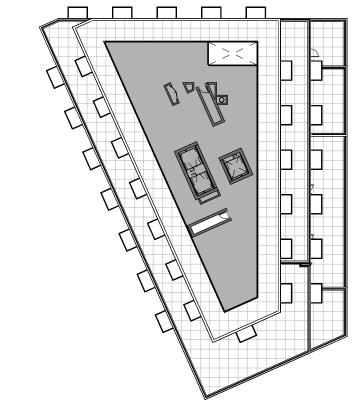


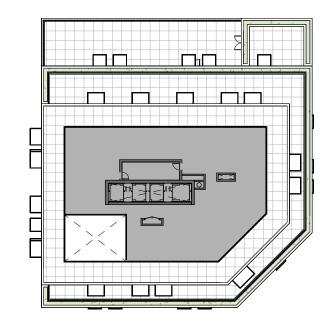





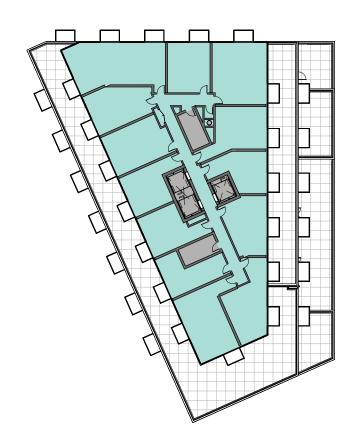

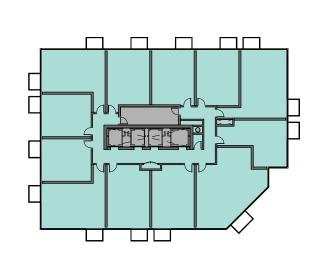


GROSS FLOOR AREA

DEDUCTION AREA

GROSS FLOOR AREA


LEVEL 08- LEVEL 37 : AREA DIAGRAM 4

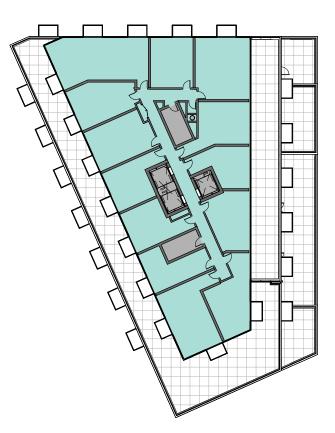


GROSS FLOOR AREA

DEDUCTION AREA


GROSS FLOOR AREA

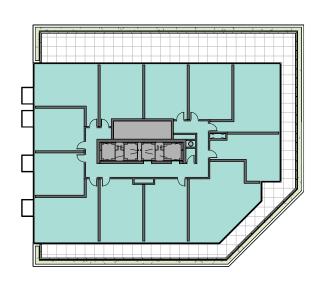


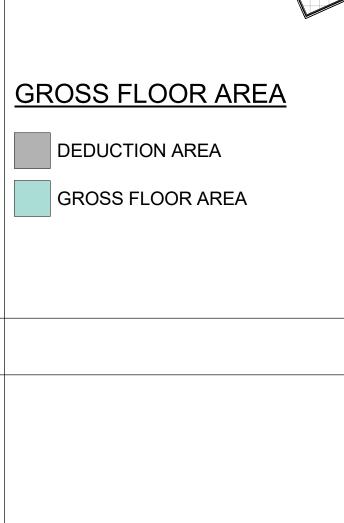



DEDUCTION AREA GROSS FLOOR AREA

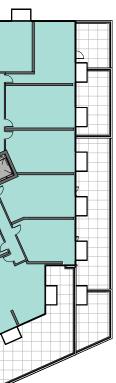

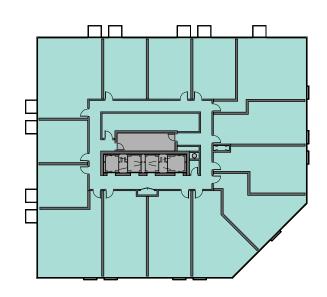

LEVEL 06 : AREA DIAGRAM 2



LEVEL 05 : AREA DIAGRAM 1

1. Copyright of this drawing is reserved by the Architect. The drawing, and all associated documents are instruments of service by the Architect. The drawing, and the information contained therein, may not be reproduced in whole or in part without prior written permission of the Architect.

2. These Contract Documents are the property of the Architect. The Architect bears no responsibility for the interpretation of these documents by the Contractor. Upon written application the Architect will provide written/graphic clarification or supplementary information regarding the intent of the Contract Documents. The Architect will review Shop Drawings submitted by the Contractor for design conformance only.

3. Drawings are not to be scaled for construction. The Contractor is to verify all existing conditions and dimensions required to perform the work and report and discrepancies with the Contract Documents to the Architect before commencing any work.

4. Positions of exposed finishes for mechanical or electrical devised, fitting and fixtures are indicated on architectural drawings. The location shown on the architectural drawing govern over the mechanical and electrical drawings. Those items not clearly located will be located as directed by the Architect.

5. These drawings are not to be used for construction unless noted below as "Issued for Construction".


6. All work is to be carried out in conformance with the Code and Bylaws of the Authorities having jurisdiction.

7. The Architect of these plans and specifications gives no warranty or representation to any party about the constructability of the building(s) represented by them. All contractors or subcontractors must satisfy themselves when bidding and at all times ensure that they can properly construct the work represented by these plans.

No	Issued For	Date
1	Issued for ZBA	2024-06-07

WALLMANARCHITECTS

99 Spadina Avenue, Suite 600 Toronto, Ontatrio M5V 3P8 t 416 340 1870 f 416 340 1871 www.wallmanarchitects.com

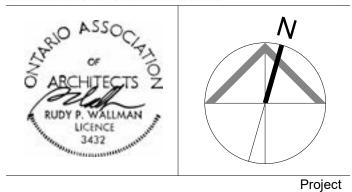

1050 Markham Road

1050 Markham Road, Toronto, Ontario, M1H 2Y5

Client

CAPREIT


Drawing Title


Drawing No.

AREA DIAGRAMS


A1.21

1 : 500	Scale
	Drawn by
	Checked by
23-11	Project No.
2024-06-07	Date

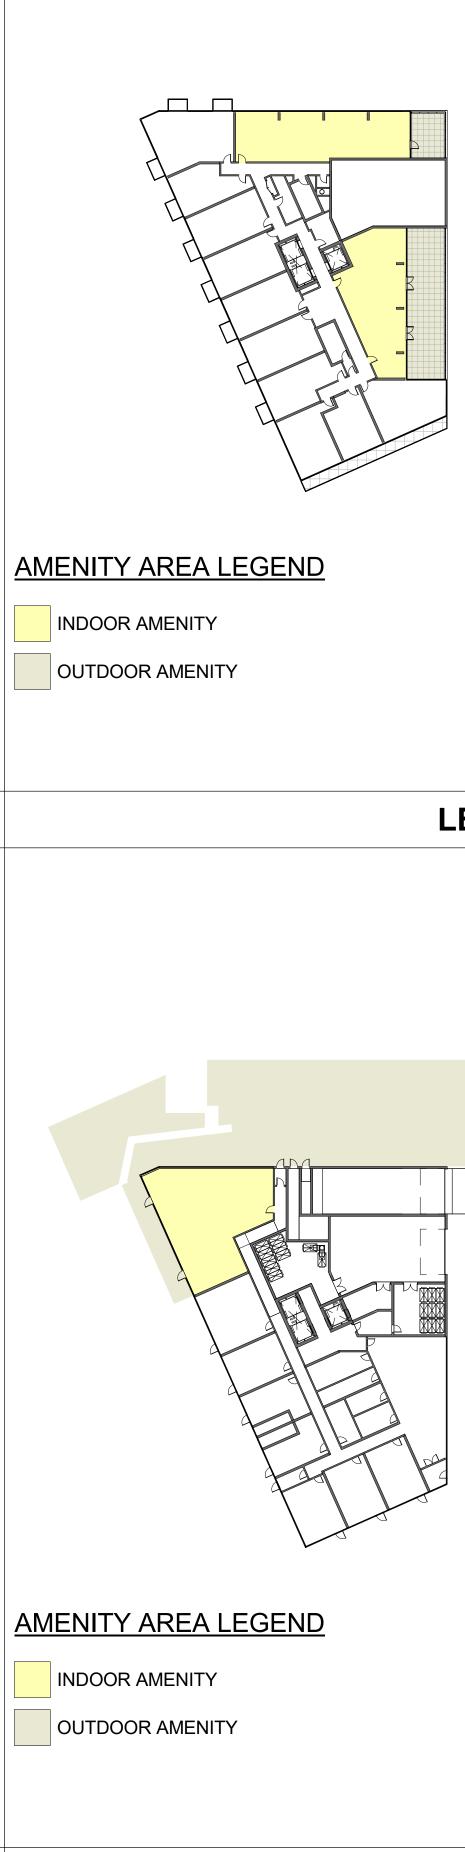

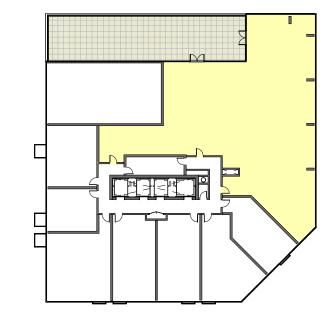

LEVEL 02 : AREA DIAGRAM 2

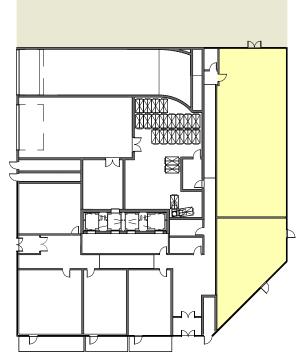

3. Drawings are not to be scaled for construction. The Contractor is to verify all existing conditions and dimensions required to perform the work and report and discrepancies with the Contract Documents to the Architect before commencing any work.

conformance only.

 Positions of exposed finishes for mechanical or electrical devised, fitting and fixtures are indicated on architectural drawings. The location shown on the architectural drawing govern over the mechanical and electrical drawings. Those items not clearly located will be located as directed by the Architect.

2. These Contract Documents are the property of the Architect. The Architect bears no responsibility for the interpretation of these documents by the Contractor. Upon written application the Architect will provide written/graphic clarification or supplementary information regarding the intent of the Contract Documents. The Architect will review Shop Drawings submitted by the Contractor for design conformance only.

1. Copyright of this drawing is reserved by the Architect. The drawing, and all associated documents are instruments of service by the Architect. The drawing, and the information contained therein, may not be reproduced in whole or in part without prior written permission of the Architect.

5. These drawings are not to be used for construction unless noted below as "Issued for Construction".


All work is to be carried out in conformance with the Code and Bylaws of the Authorities having jurisdiction.

7. The Architect of these plans and specifications gives no warranty or representation to any party about the constructability of the building(s) represented by them. All contractors or subcontractors must satisfy themselves when bidding and at all times ensure that they can properly construct the work represented by these plans.

Ν	lo	Issued For	Date
	1	Issued for ZBA	2024-06-07

WALLMANARCHITECTS

99 Spadina Avenue, Suite 600 Toronto, Ontatrio M5V 3P8 t 416 340 1870 f 416 340 1871 www.wallmanarchitects.com

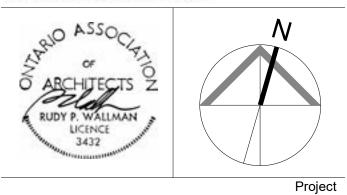

1050 Markham Road

1050 Markham Road, Toronto, Ontario, M1H 2Y5

Client

CAPREIT

Drawing Title


Drawing No.

AMENITY DIAGRAMS

1 : 500	Scale
	Drawn by
	Checked by
23-11	Project No.
2024-06-07	Date

A1.22

LEVEL 01 : AREA DIAGRAM 1

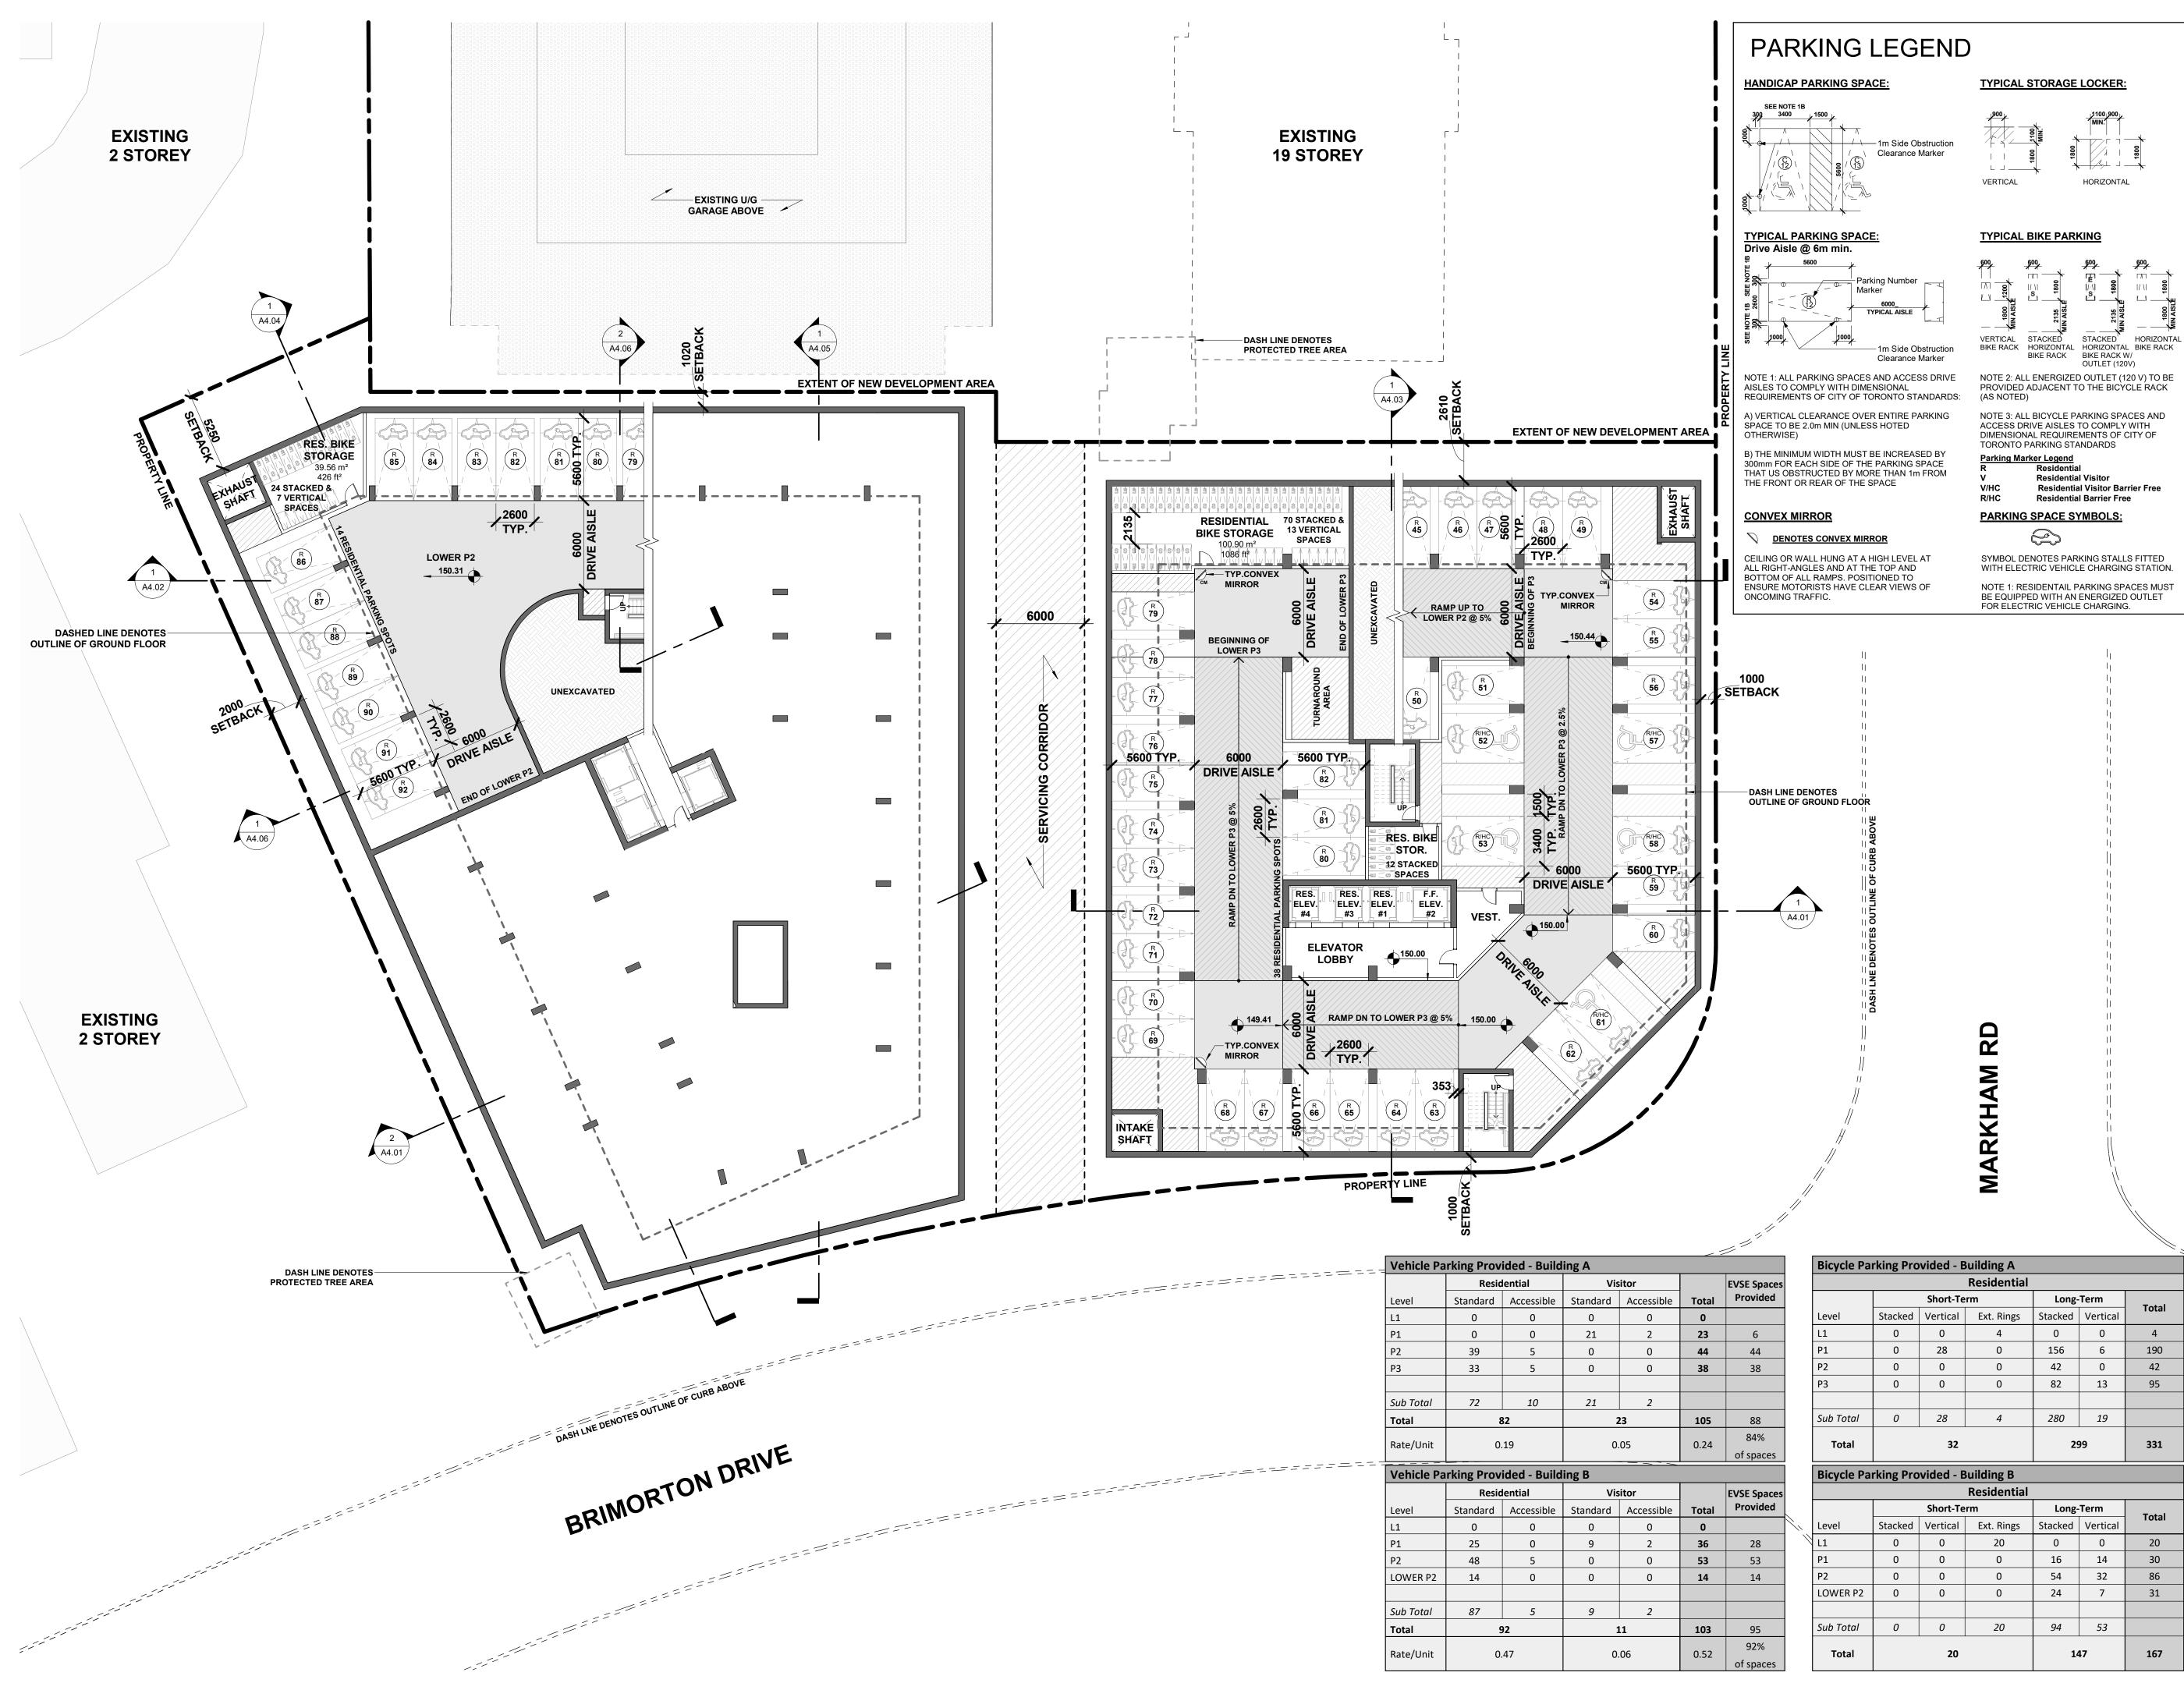

2. These Contract Documents are the property of the Architect. The Architect bears no responsibility for the interpretation of these documents by the Contractor. Upon written application the Architect will provide written/graphic clarification or supplementary information regarding the intent of the Contract Documents. The Architect will review Shop Drawings submitted by the Contractor for design conformance only.

3. Drawings are not to be scaled for construction. The Contractor is to verify all existing conditions and dimensions required to perform the work and report and discrepancies with the Contract Documents to the Architect before commencing any work.

4. Positions of exposed finishes for mechanical or electrical devised, fitting and fixtures are indicated on architectural drawings. The location shown on the architectural drawing govern over the mechanical and electrical drawings. Those items not clearly located will be located as directed by the Architect.

5. These drawings are not to be used for construction unless noted below as "Issued for Construction".

6. All work is to be carried out in conformance with the Code and Bylaws of the Authorities having jurisdiction.


|/\| 8

7. The Architect of these plans and specifications gives no warranty or representation to any party about the constructability of the building(s) represented by them. All contractors or subcontractors must satisfy themselves when bidding and at all times ensure that they can properly construct the work represented by these plans.

No	Issued For	Date
1	Issued for ZBA	2024-06-07

WALLMANARCHITECTS

99 Spadina Avenue, Suite 600 Toronto, Ontatrio M5V 3P8 t 416 340 1870 f 416 340 1871 www.wallmanarchitects.com

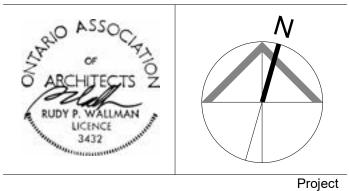

1050 Markham Road

1050 Markham Road, Toronto, Ontario, M1H 2Y5

CAPREIT

Drawing Title


Client

LOWER P2 & P3 PARKING LEVEL

1:200	Scale
	Drawn by
	Checked by
23-11	Project No.
2024-06-07	Date
	Drawing No.

Provided	
6	
44	
38	
88	
84%	
of spaces	
of spaces	
of spaces EVSE Spaces Provided	
EVSE Spaces	
EVSE Spaces	
EVSE Spaces Provided	
EVSE Spaces Provided 28	
EVSE Spaces Provided 28 53	
EVSE Spaces Provided 28 53	

	Bicycle Pa	Bicycle Parking Provided - Building A					
		Residential					
		Short-Term			Long-Term		
	Level	Stacked	Vertical	Ext. Rings	Stacked	Vertical	Total
	L1	0	0	4	0	0	4
	P1	0	28	0	156	6	190
	P2	0	0	0	42	0	42
	Р3	0	0	0	82	13	95
	Sub Total	0	28	4	280	19	
	Total		32		29	99	331
	Bicycle Pa	rking Pro	ovided - Building B				
		-		Residential			
			Short-Term		Long-Term		
\sim			01101110		LONS		Total
	Level	Stacked	Vertical	Ext. Rings	Stacked	Vertical	Total
	Level L1	Stacked 0					Total 20
			Vertical	Ext. Rings	Stacked	Vertical	
	L1	0	Vertical 0	Ext. Rings 20	Stacked 0	Vertical 0	20
	L1 P1	0	Vertical 0 0	Ext. Rings 20 0	Stacked 0 16	Vertical 0 14	20 30
	L1 P1 P2	0 0 0	Vertical 0 0 0	Ext. Rings 20 0 0	Stacked 0 16 54	Vertical 0 14 32	20 30 86
	L1 P1 P2	0 0 0	Vertical 0 0 0	Ext. Rings 20 0 0	Stacked 0 16 54	Vertical 0 14 32	20 30 86

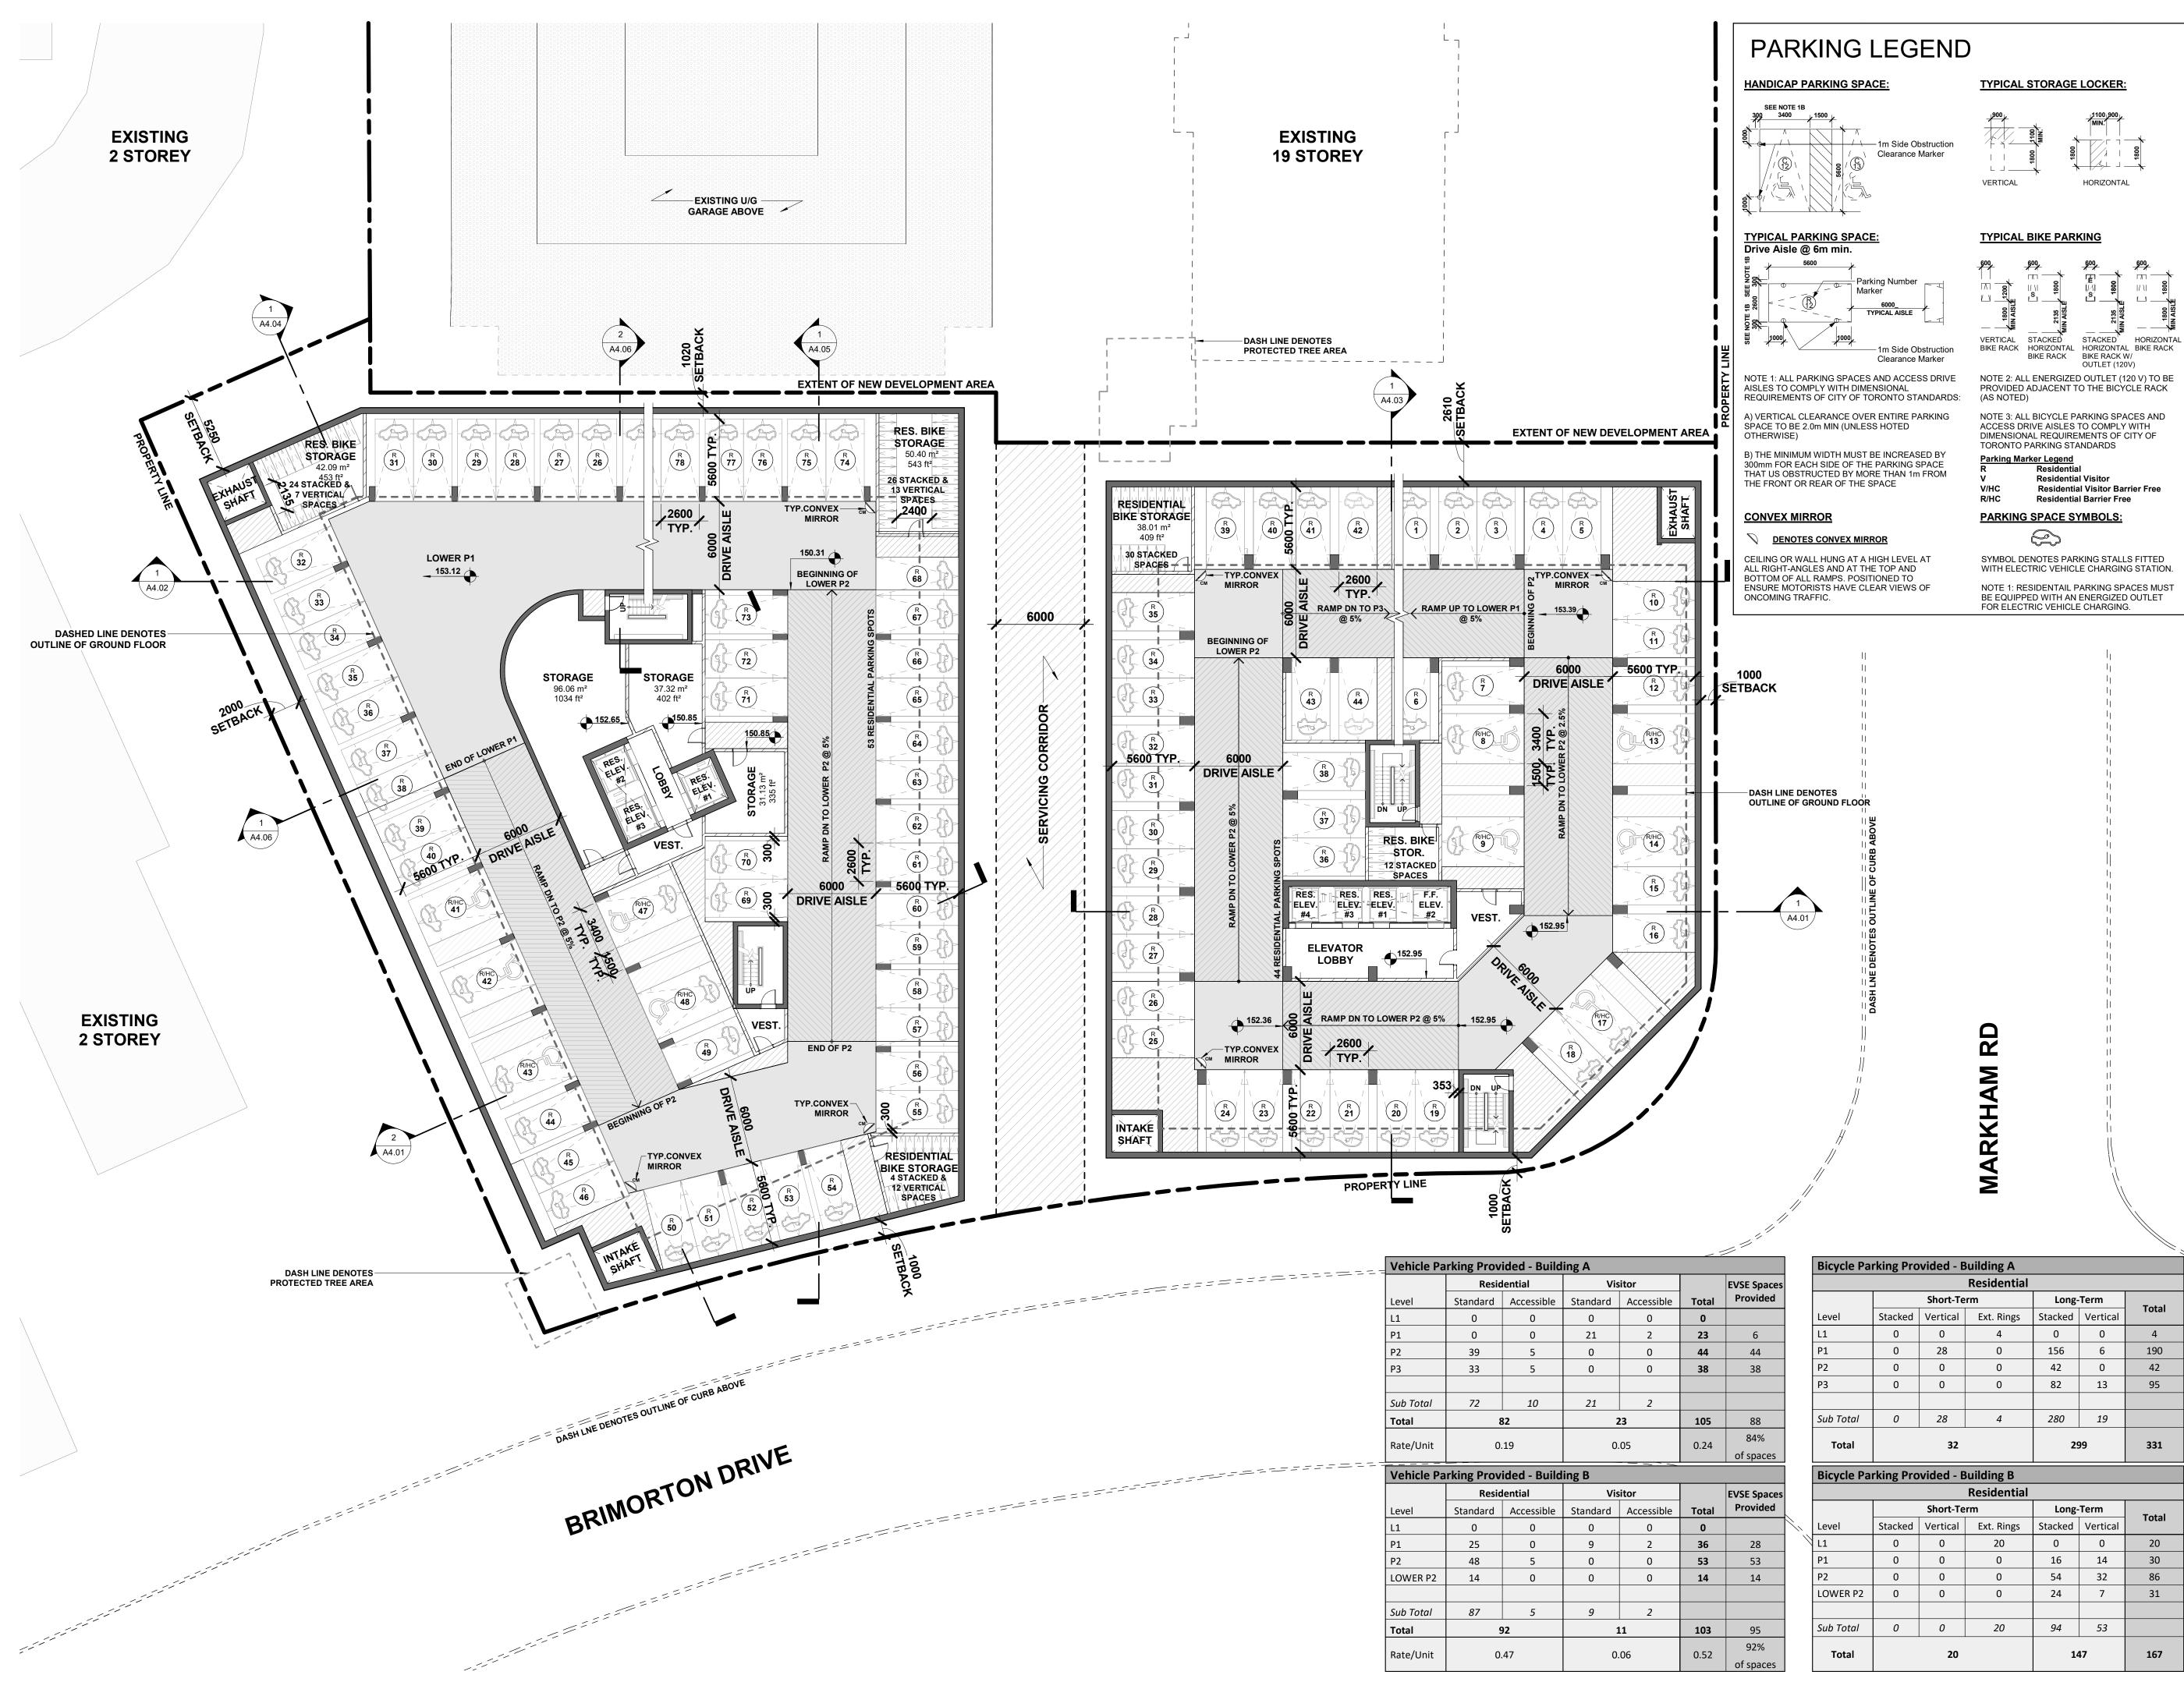

2. These Contract Documents are the property of the Architect. The Architect bears no responsibility for the interpretation of these documents by the Contractor. Upon written application the Architect will provide written/graphic clarification or supplementary information regarding the intent of the Contract Documents. The Architect will review Shop Drawings submitted by the Contractor for design conformance only.

3. Drawings are not to be scaled for construction. The Contractor is to verify all existing conditions and dimensions required to perform the work and report and discrepancies with the Contract Documents to the Architect before commencing any work.

4. Positions of exposed finishes for mechanical or electrical devised, fitting and fixtures are indicated on architectural drawings. The location shown on the architectural drawing govern over the mechanical and electrical drawings. Those items not clearly located will be located as directed by the Architect.

5. These drawings are not to be used for construction unless noted below as "Issued for Construction".


6. All work is to be carried out in conformance with the Code and Bylaws of the Authorities having jurisdiction.

7. The Architect of these plans and specifications gives no warranty or representation to any party about the constructability of the building(s) represented by them. All contractors or subcontractors must satisfy themselves when bidding and at all times ensure that they can properly construct the work represented by these plans.

No	Issued For	Date
1	Issued for ZBA	2024-06-07

WALLMANARCHITECTS

99 Spadina Avenue, Suite 600 Toronto, Ontatrio M5V 3P8 t 416 340 1870 f 416 340 1871 www.wallmanarchitects.com

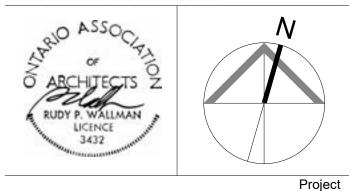

1050 Markham Road

1050 Markham Road, Toronto, Ontario, M1H 2Y5

CAPREIT

Client


Drawing Title

Drawing No.

PARKING LEVEL 2

1:200	Scale
	Drawn by
	Checked by
23-11	Project No.
2024-06-07	Date

		<u> </u>		U			
		Residential					
			Short-Term Long-Term				Total
//	Level	Stacked	Vertical	Ext. Rings	Stacked	Vertical	TOLAT
$\langle \rangle$	L1	0	0	20	0	0	20
	P1	0	0	0	16	14	30
	P2	0	0	0	54	32	86
	LOWER P2	0	0	0	24	7	31
	Sub Total	0	0	20	94	53	
	Total		20			47	167

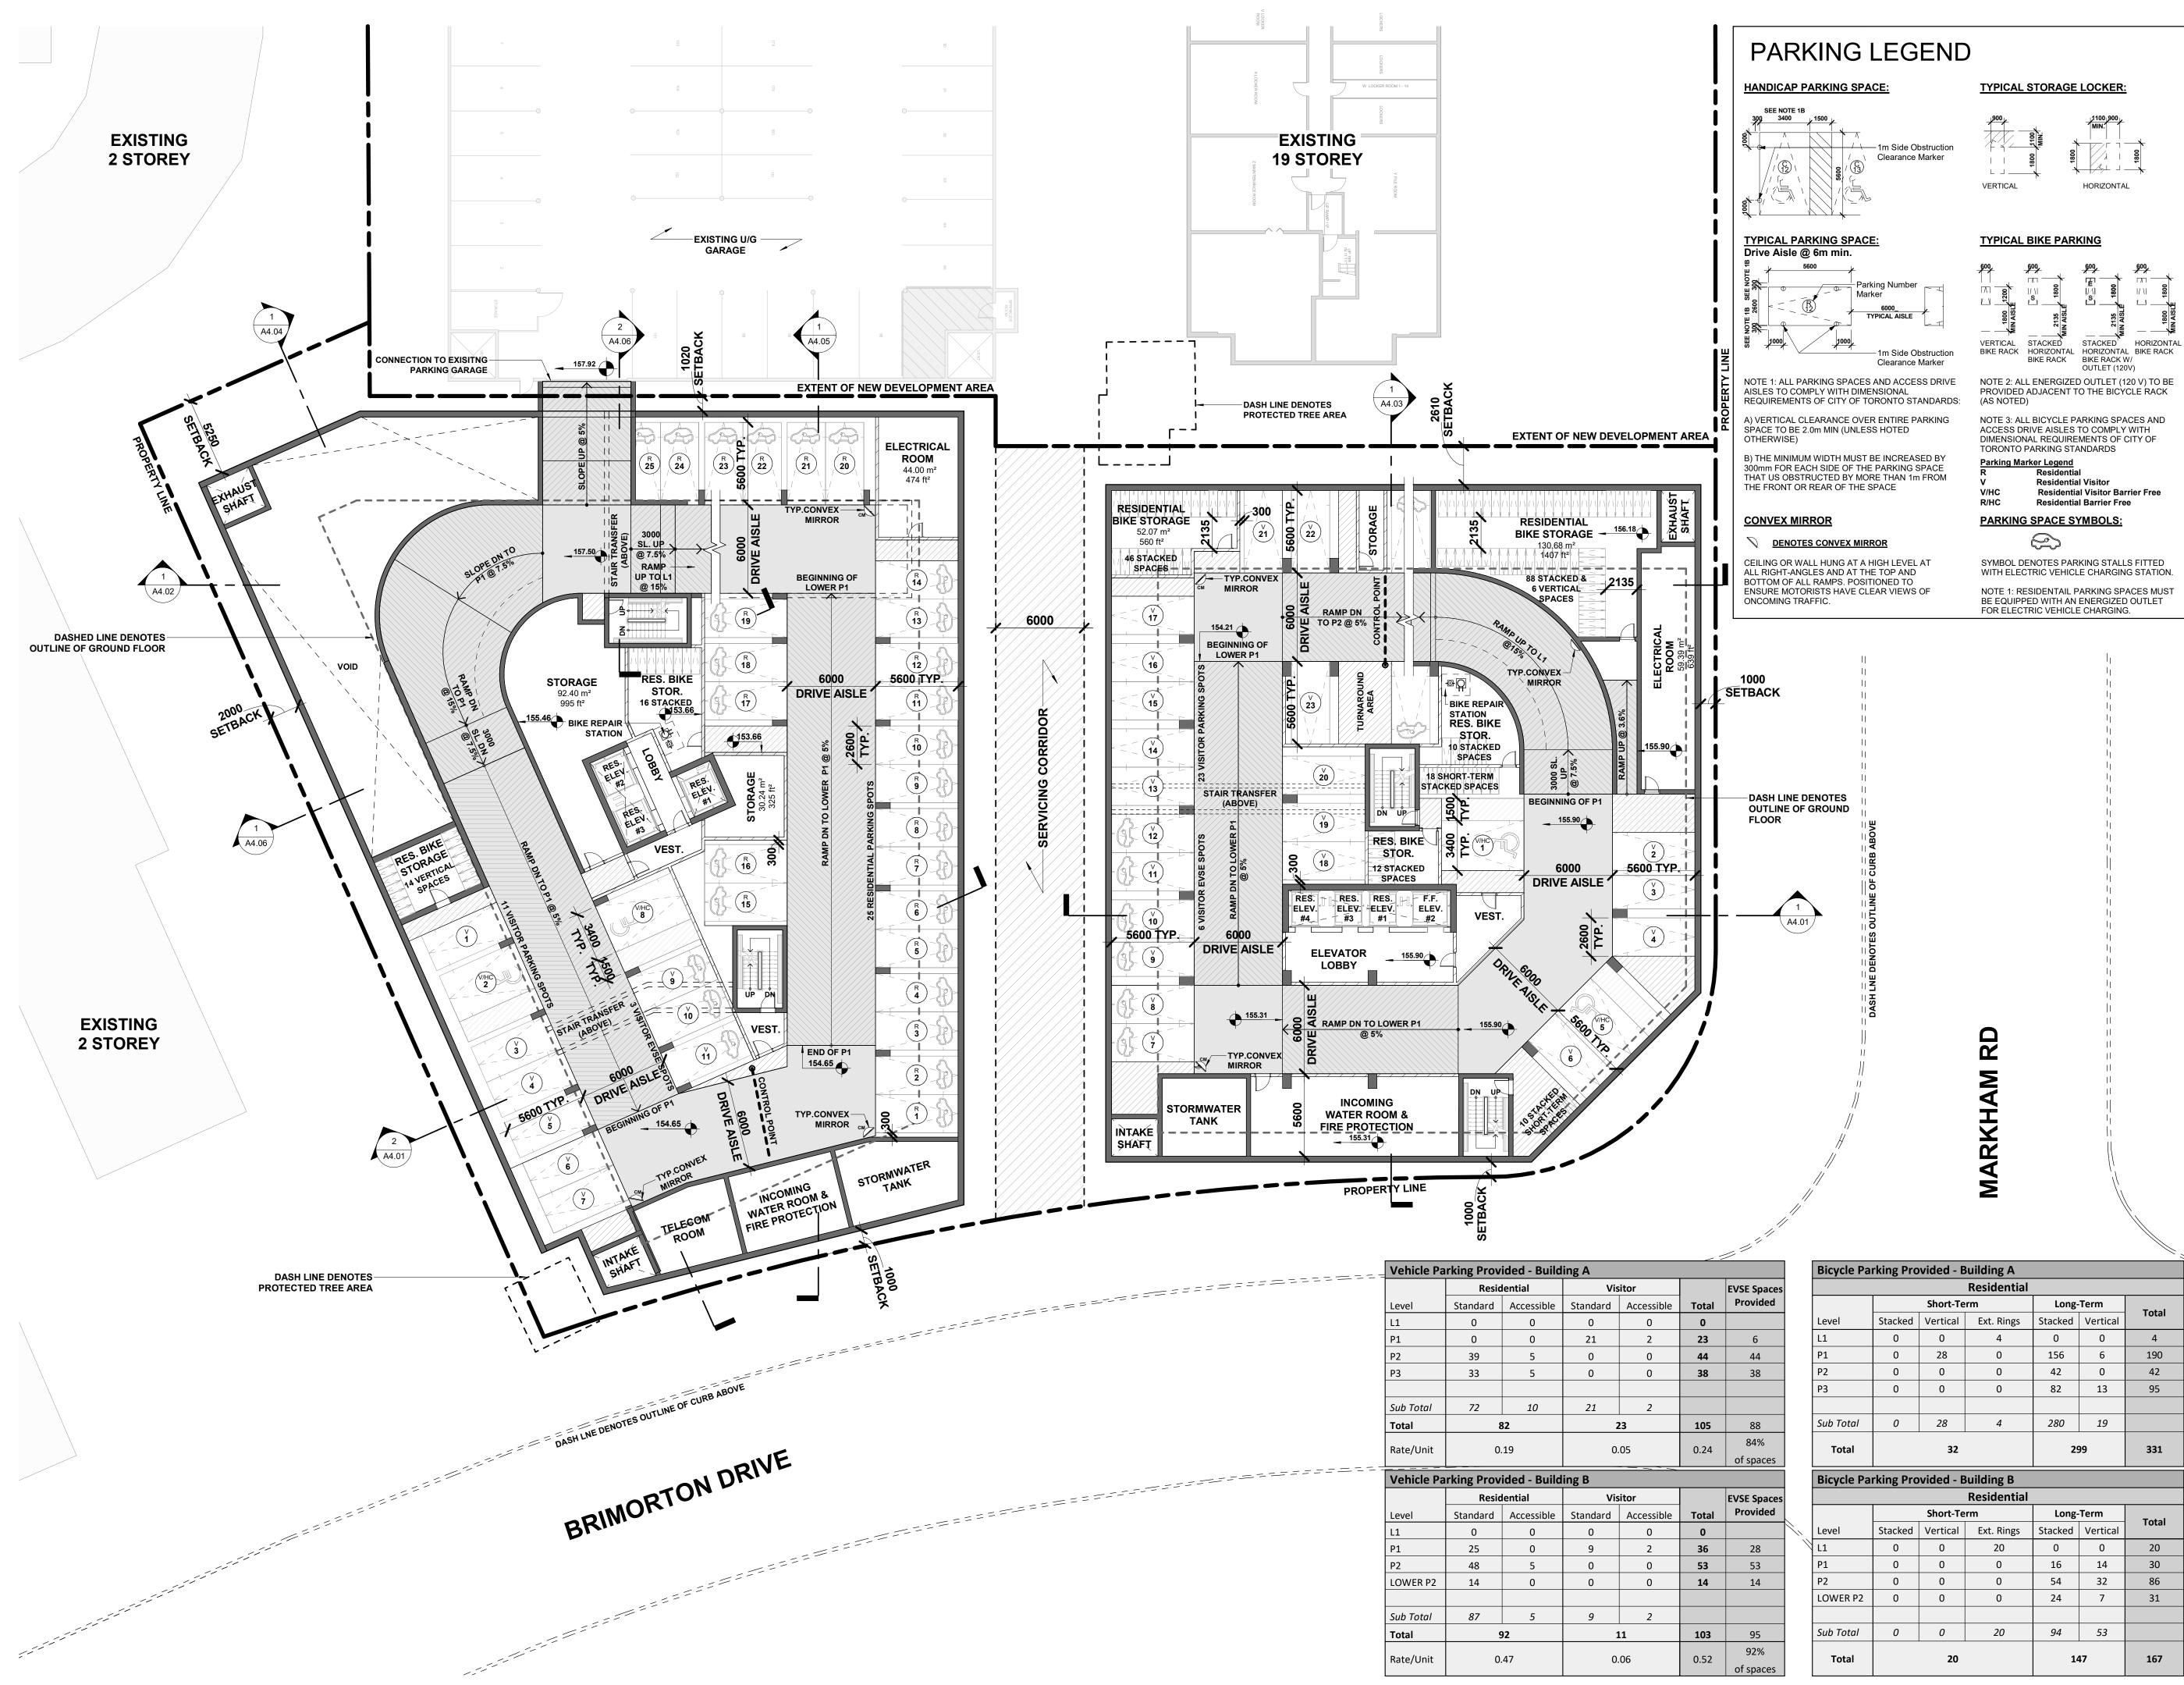

2. These Contract Documents are the property of the Architect. The Architect bears no responsibility for the interpretation of these documents by the Contractor. Upon written application the Architect will provide written/graphic clarification or supplementary information regarding the intent of the Contract Documents. The Architect will review Shop Drawings submitted by the Contractor for design conformance only.

3. Drawings are not to be scaled for construction. The Contractor is to verify all existing conditions and dimensions required to perform the work and report and discrepancies with the Contract Documents to the Architect before commencing any work.

4. Positions of exposed finishes for mechanical or electrical devised, fitting and fixtures are indicated on architectural drawings. The location shown on the architectural drawing govern over the mechanical and electrical drawings. Those items not clearly located will be located as directed by the Architect.

5. These drawings are not to be used for construction unless noted below as "Issued for Construction".


6. All work is to be carried out in conformance with the Code and Bylaws of the Authorities having jurisdiction.

7. The Architect of these plans and specifications gives no warranty or representation to any party about the constructability of the building(s) represented by them. All contractors or subcontractors must satisfy themselves when bidding and at all times ensure that they can properly construct the work represented by these plans.

No	Issued For	Date
1	Issued for ZBA	2024-06-07

WALLMANARCHITECTS

99 Spadina Avenue, Suite 600 Toronto, Ontatrio M5V 3P8 t 416 340 1870 f 416 340 1871 www.wallmanarchitects.com

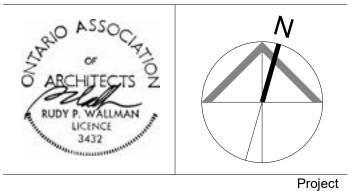

1050 Markham Road

1050 Markham Road, Toronto, Ontario, M1H 2Y5

CAPREIT

Total

4 190

42

95

20

30

86

31

167

Drawing Title

Drawing No.

PARKING LEVEL 1

1:200	Scale
	Drawn by
	Checked by
23-11	Project No.
2024-06-07	Date

EVSE Spaces Provided
28
53
14
05


84%		т
of spaces		•
		Bicy
VSE Spaces		
Provided		
	<u>\</u> ,	Leve
28	Ň	L1
53		P1
14		P2
		LOW
95		Sub
92%		т

Residential						
	Short-Term			Long-Term		
	Stacked	Vertical	Ext. Rings	Stacked	Vertical	
	0	0	4	0	0	
	0	28	0	156	6	
	0	0	0	42	0	
	0	0	0	82	13	
tal	0	28	4	280	19	
al			299			
ai	32		2:	55		
e Parking Provided - Building B						
Residential						
	Short-Term		Long-	Term		
	Stacked	Vertical	Ext. Rings	Stacked	Vertical	
	0	0	20	0	0	
	0	0	0	16	14	
	0	0	0	54	32	
		•	9	24	1	

RKHAM RD	

A2.03

Client

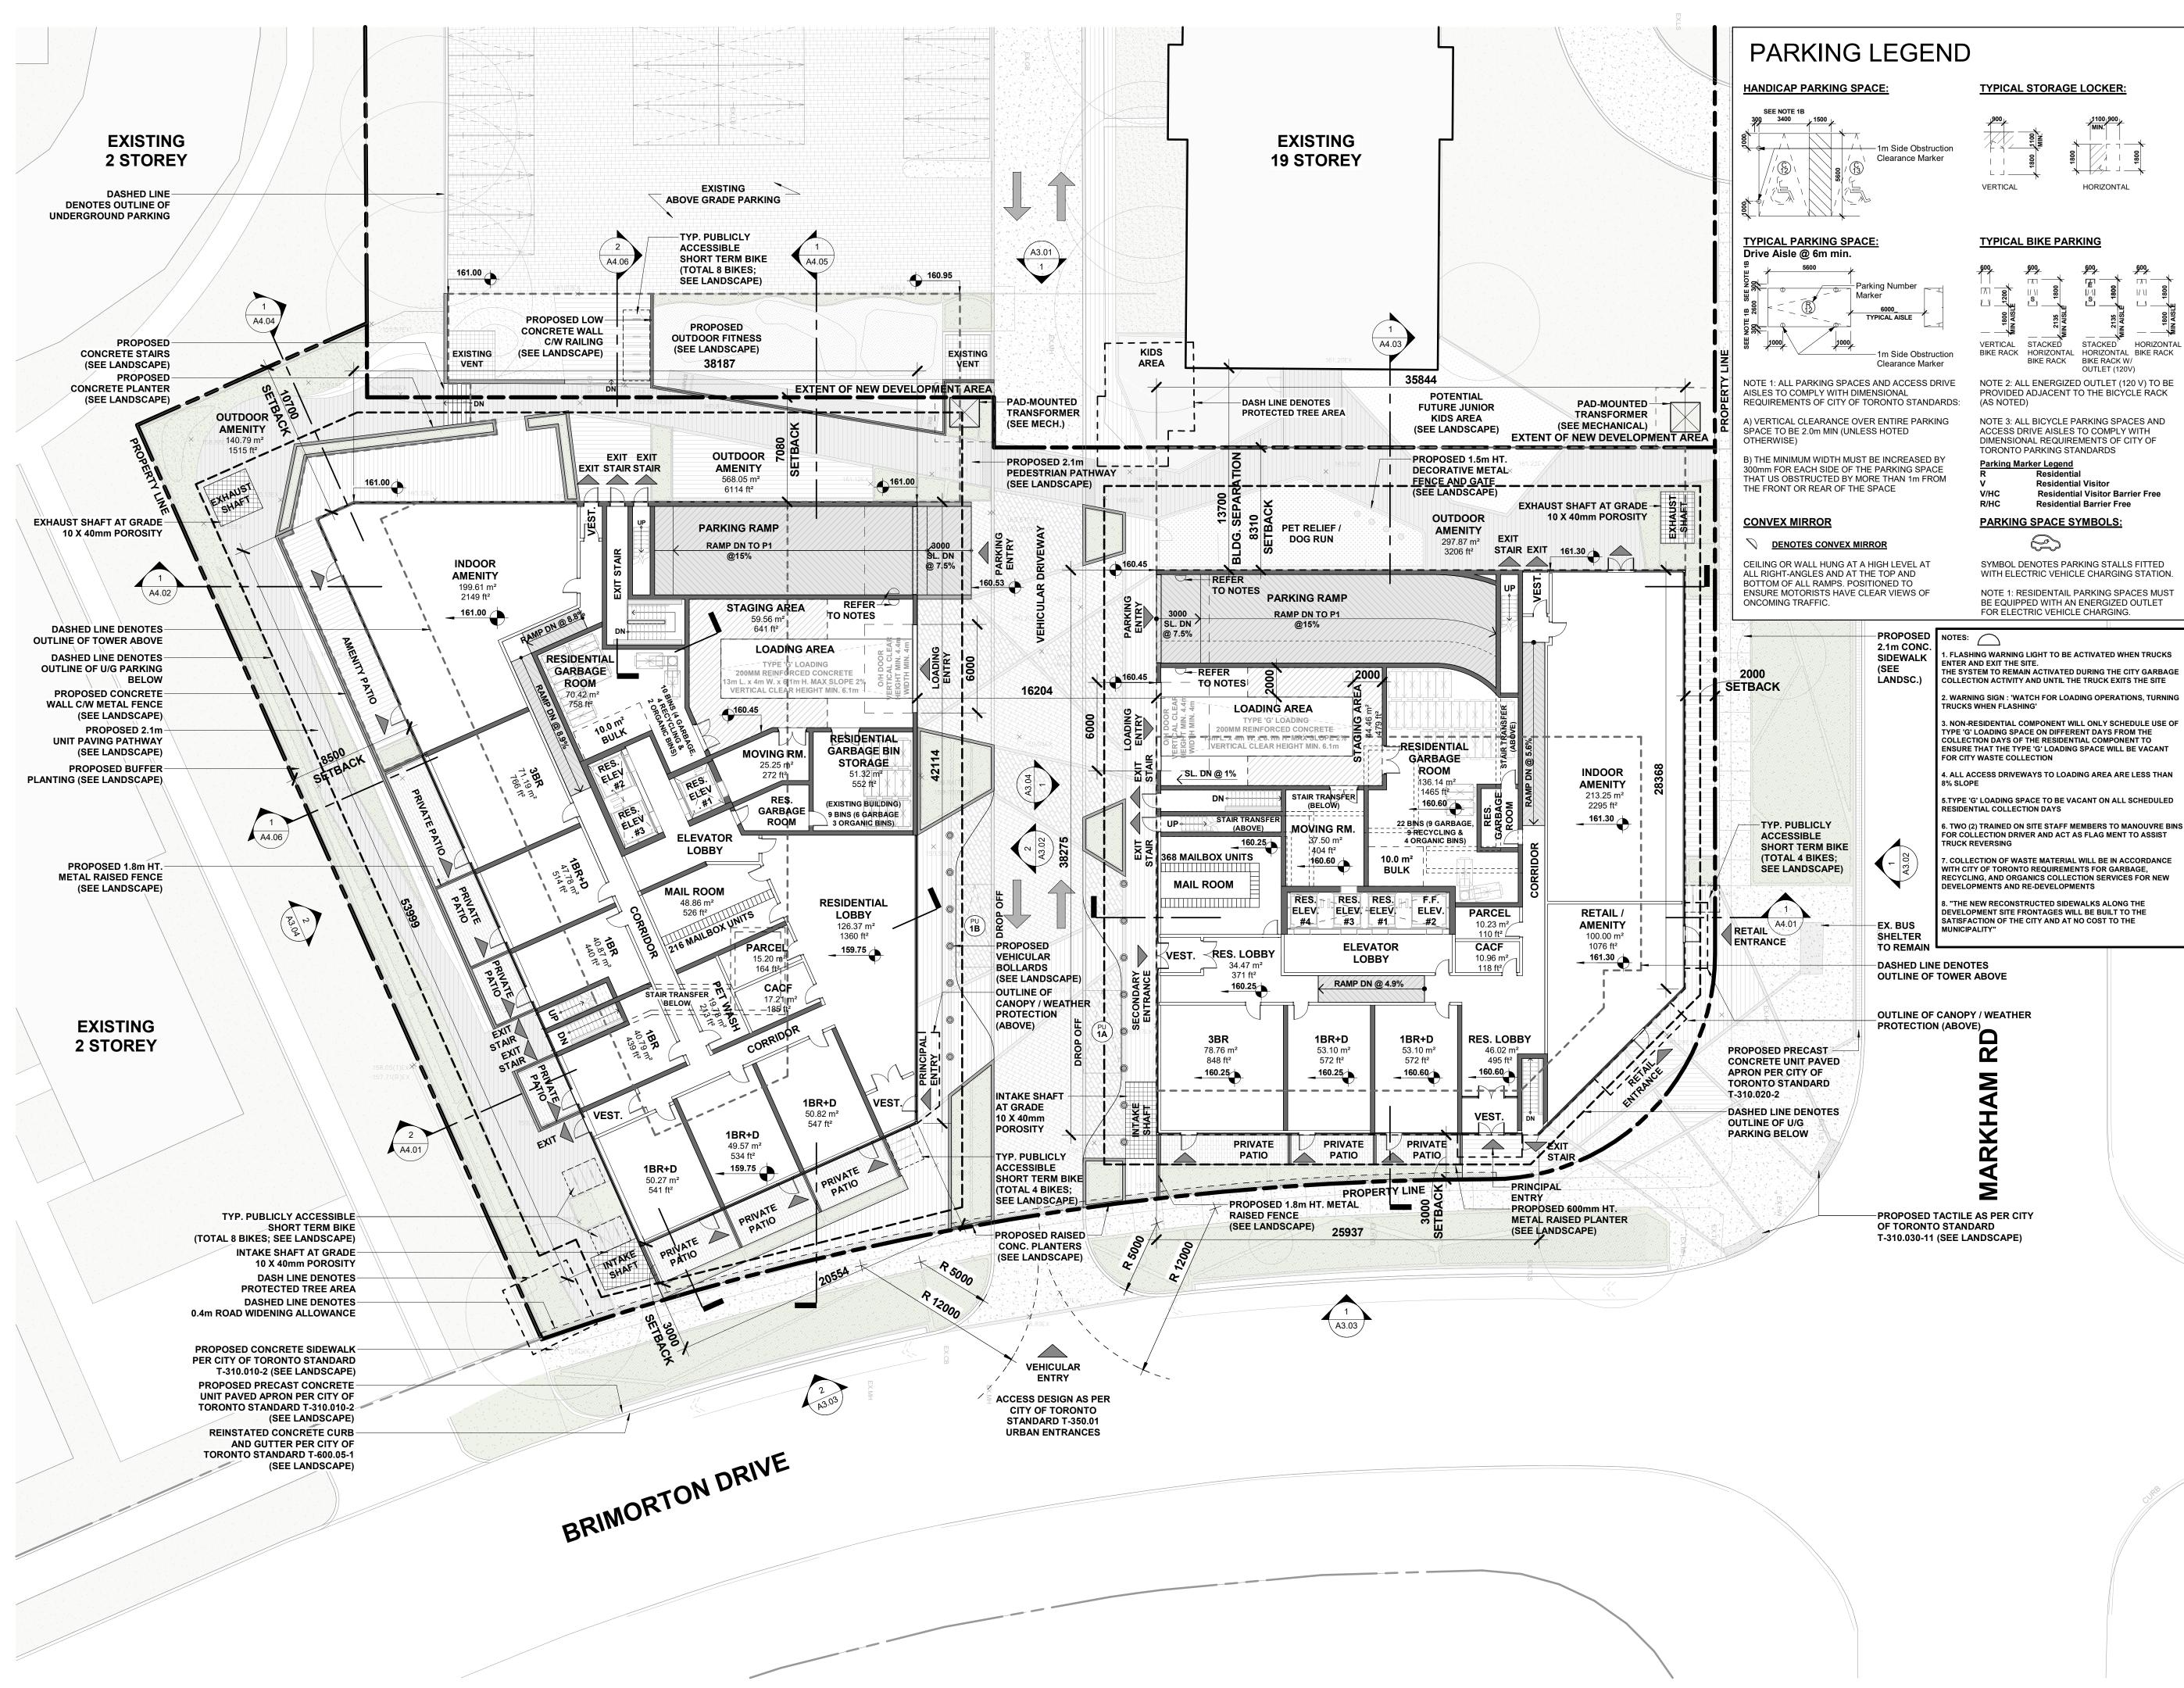

2. These Contract Documents are the property of the Architect. The Architect bears no responsibility for the interpretation of these documents by the Contractor. Upon written application the Architect will provide written/graphic clarification or supplementary information regarding the intent of the Contract Documents. The Architect will review Shop Drawings submitted by the Contractor for design conformance only.

3. Drawings are not to be scaled for construction. The Contractor is to verify all existing conditions and dimensions required to perform the work and report and discrepancies with the Contract Documents to the Architect before commencing any work.

4. Positions of exposed finishes for mechanical or electrical devised, fitting and fixtures are indicated on architectural drawings. The location shown on the architectural drawing govern over the mechanical and electrical drawings. Those items not clearly located will be located as directed by the Architect.

5. These drawings are not to be used for construction unless noted below as "Issued for Construction".


6. All work is to be carried out in conformance with the Code and Bylaws of the Authorities having jurisdiction.

7. The Architect of these plans and specifications gives no warranty or representation to any party about the constructability of the building(s) represented by them. All contractors or subcontractors must satisfy themselves when bidding and at all times ensure that they can properly construct the work represented by these plans.

No	Issued For	Date
1	Issued for ZBA	2024-06-07

WALLMANARCHITECTS

99 Spadina Avenue, Suite 600 Toronto, Ontatrio M5V 3P8 t 416 340 1870 f 416 340 1871 www.wallmanarchitects.com

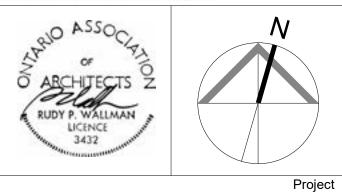

1050 Markham Road

1050 Markham Road, Toronto, Ontario, M1H 2Y5

CAPREIT

Client


Drawing Title

LEVEL 1 FLOOR PLAN

1:200	Scale
	Drawn by
	Checked by
23-11	Project No.
2024-06-07	Date
	Drawing No.

A2.04

Drawing No

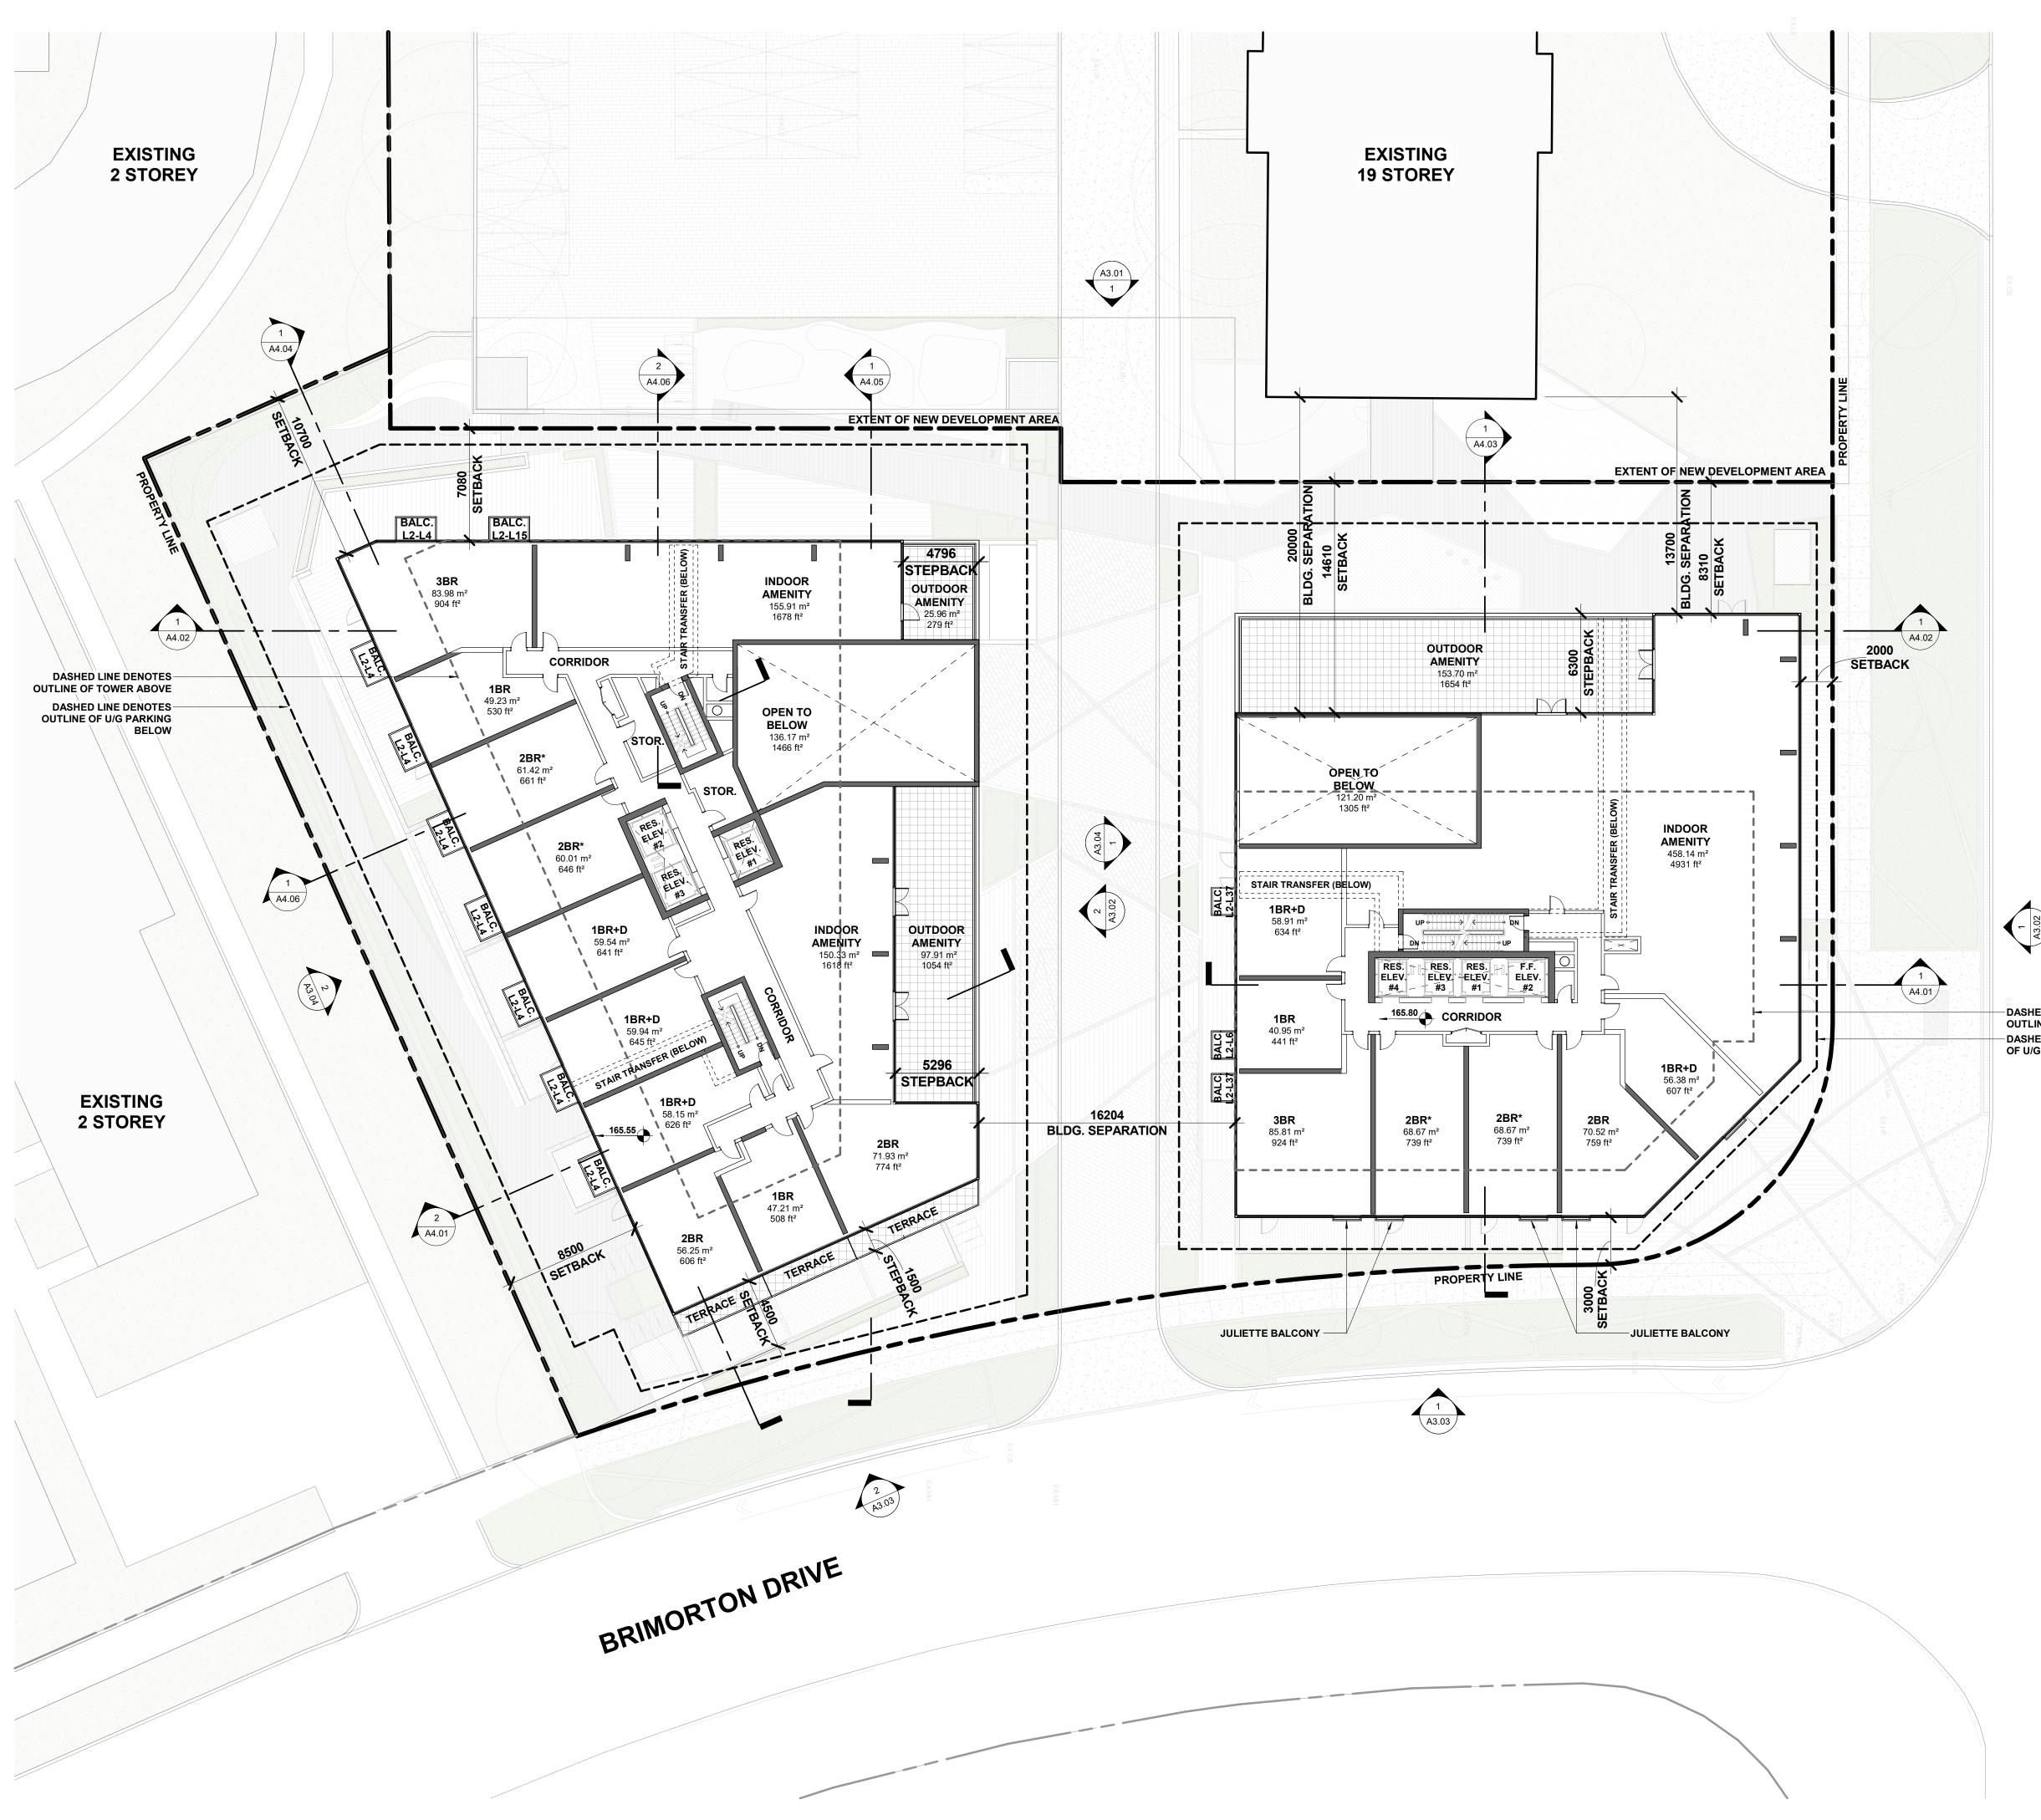

2. These Contract Documents are the property of the Architect. The Architect bears no responsibility for the interpretation of these documents by the Contractor. Upon written application the Architect will provide written/graphic clarification or supplementary information regarding the intent of the Contract Documents. The Architect will review Shop Drawings submitted by the Contractor for design conformance only.

3. Drawings are not to be scaled for construction. The Contractor is to verify all existing conditions and dimensions required to perform the work and report and discrepancies with the Contract Documents to the Architect before commencing any work.

4. Positions of exposed finishes for mechanical or electrical devised, fitting and fixtures are indicated on architectural drawings. The location shown on the architectural drawing govern over the mechanical and electrical drawings. Those items not clearly located will be located as directed by the Architect.

5. These drawings are not to be used for construction unless noted below as "Issued for Construction".

All work is to be carried out in conformance with the Code and Bylaws of the Authorities having jurisdiction.

7. The Architect of these plans and specifications gives no warranty or representation to any party about the constructability of the building(s) represented by them. All contractors or subcontractors must satisfy themselves when bidding and at all times ensure that they can properly construct the work represented by these plans.


Date No Issued For 1 Issued for ZBA 2024-06-07

DASHED LINE DENOTES - DASHED LINE DENOTES OUTLINE OF U/G PARKING BELOW

> RD \geq MARKH

WALLMANARCHITECTS

99 Spadina Avenue, Suite 600 Toronto, Ontatrio M5V 3P8 t 416 340 1870 f 416 340 1871 www.wallmanarchitects.com

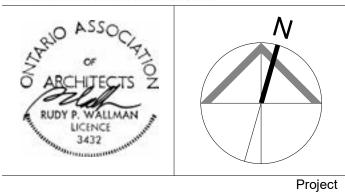

1050 Markham Road

1050 Markham Road, Toronto, Ontario, M1H 2Y5


CAPREIT

Client

Drawing Title

LEVEL 2 FLOOR PLAN

1 : 200	Scale
	Drawn by
	Checked by
23-11	Project No.
2024-06-07	Date
	Drawing No.

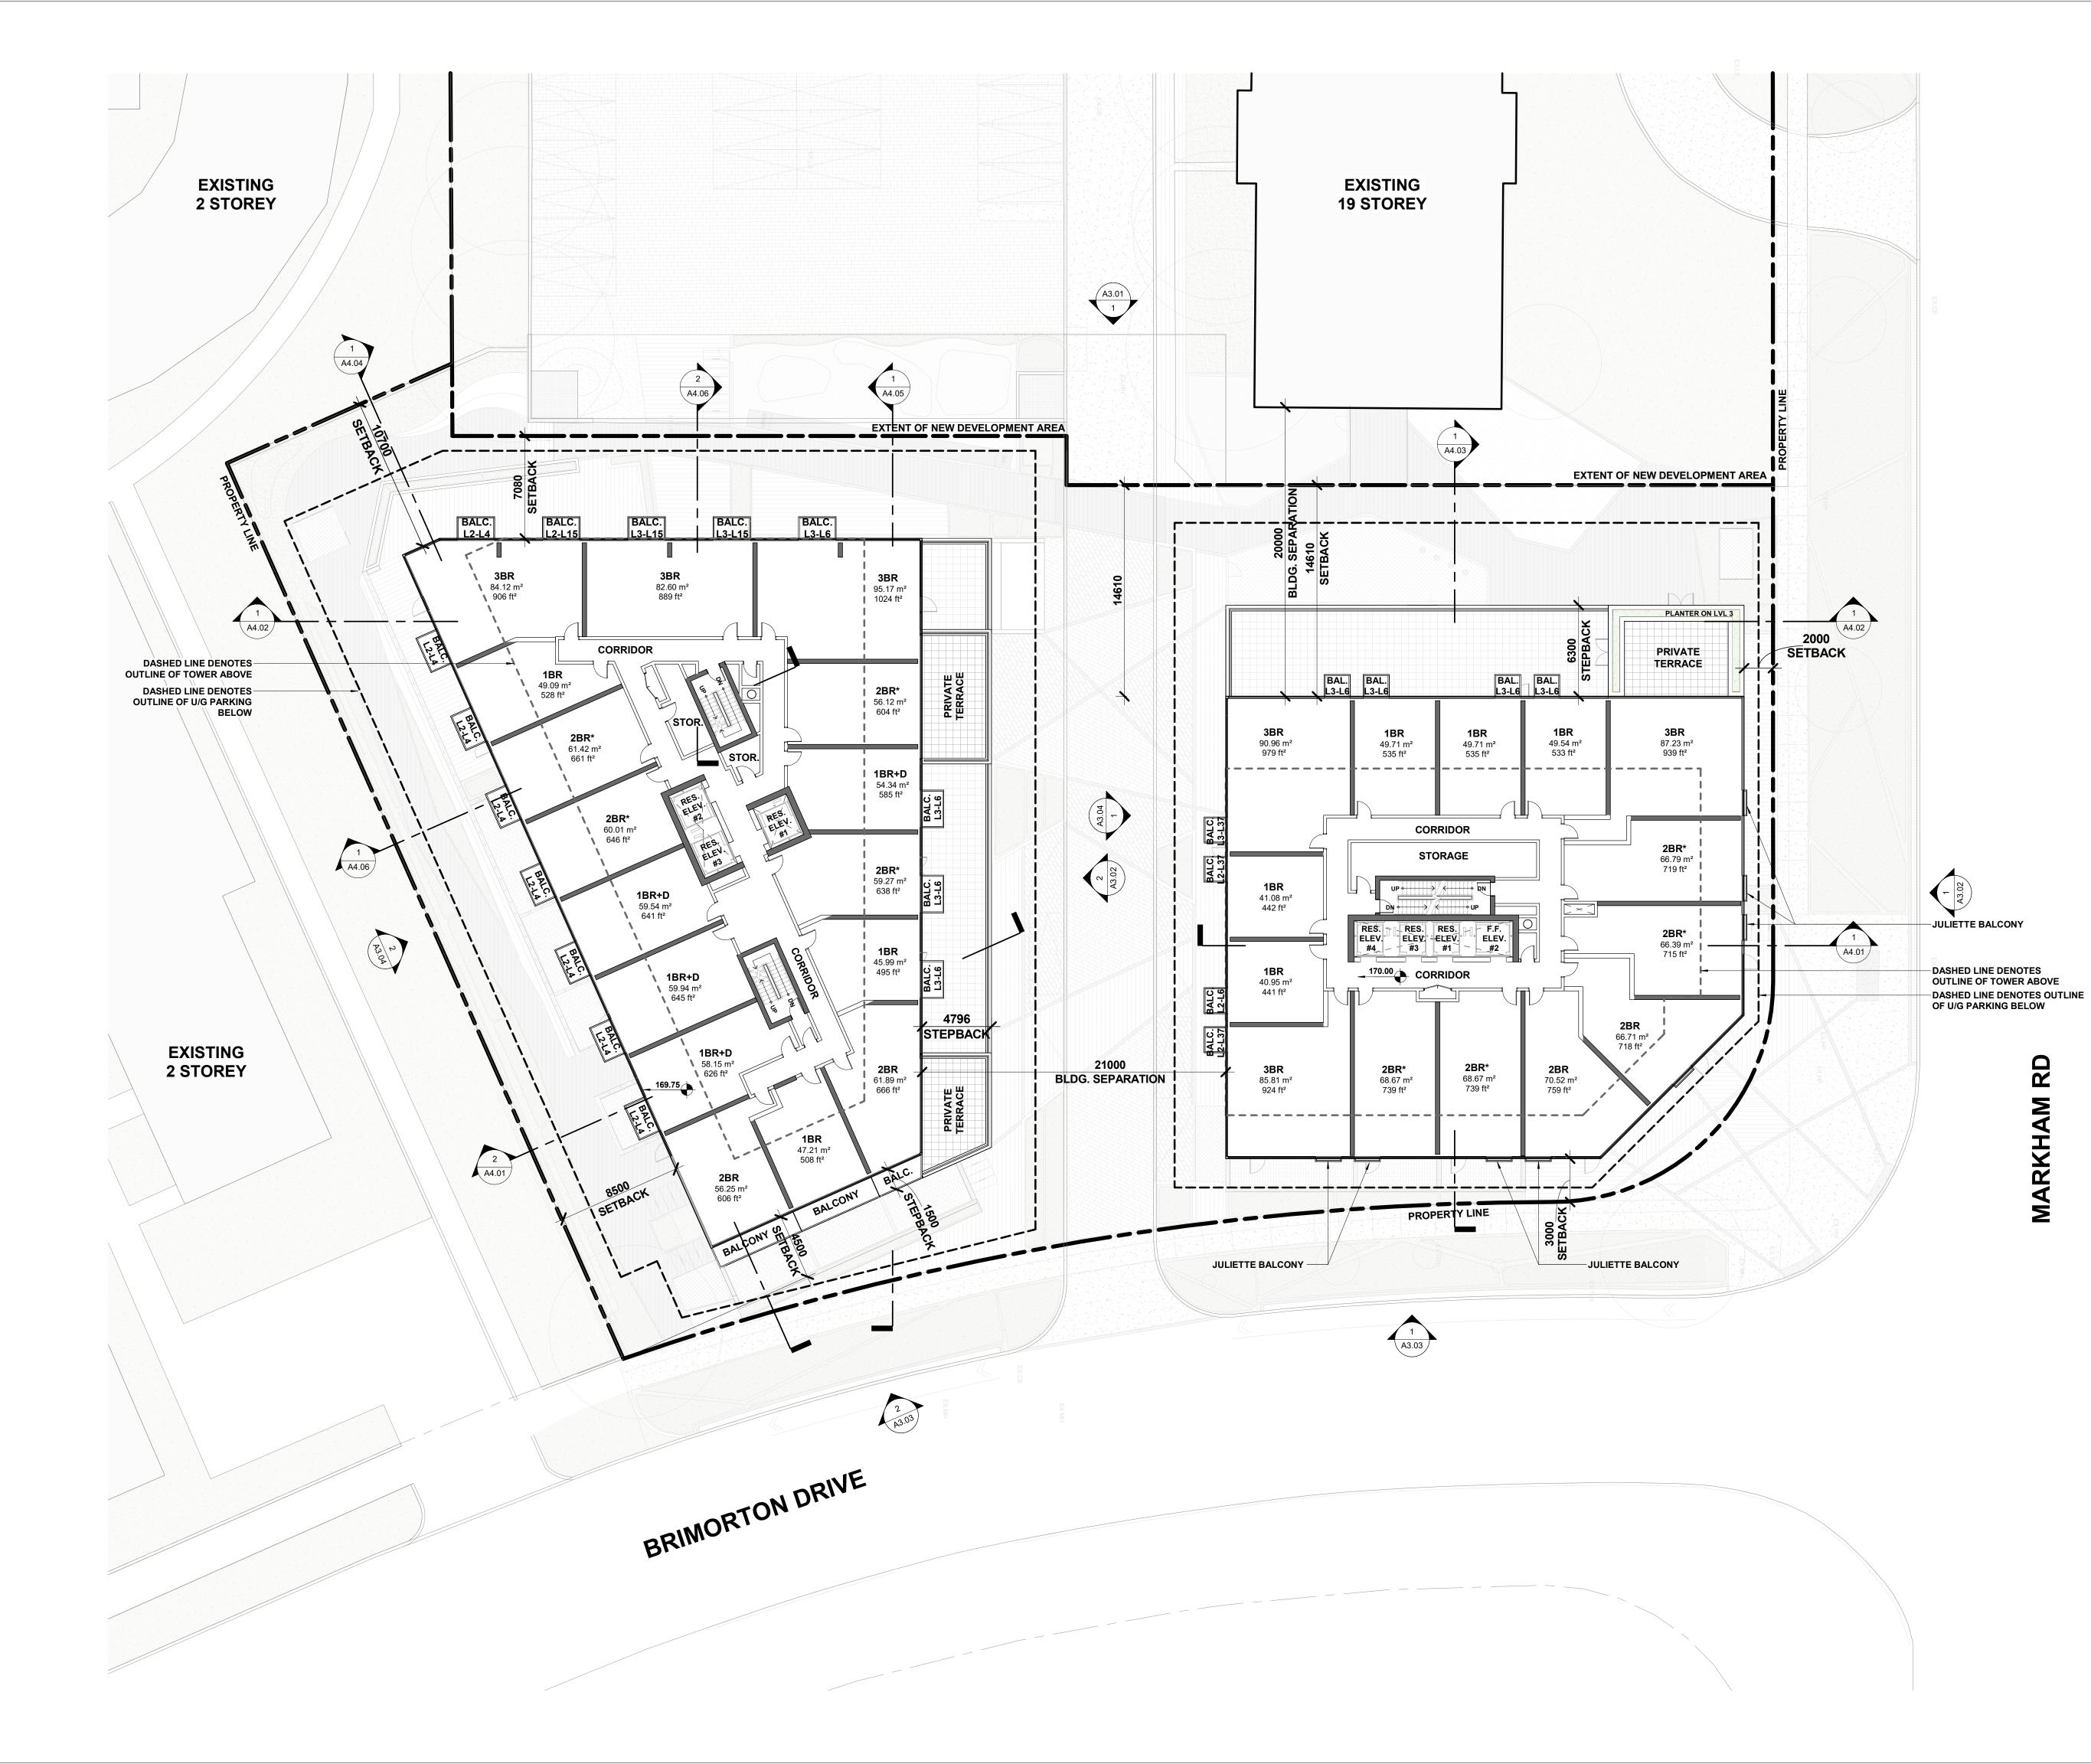

2. These Contract Documents are the property of the Architect. The Architect bears no responsibility for the interpretation of these documents by the Contractor. Upon written application the Architect will provide written/graphic clarification or supplementary information regarding the intent of the Contract Documents. The Architect will review Shop Drawings submitted by the Contractor for design conformance only.

3. Drawings are not to be scaled for construction. The Contractor is to verify all existing conditions and dimensions required to perform the work and report and discrepancies with the Contract Documents to the Architect before commencing any work.

4. Positions of exposed finishes for mechanical or electrical devised, fitting and fixtures are indicated on architectural drawings. The location shown on the architectural drawing govern over the mechanical and electrical drawings. Those items not clearly located will be located as directed by the Architect.

5. These drawings are not to be used for construction unless noted below as "Issued for Construction".


6. All work is to be carried out in conformance with the Code and Bylaws of the Authorities having jurisdiction.

7. The Architect of these plans and specifications gives no warranty or representation to any party about the constructability of the building(s) represented by them. All contractors or subcontractors must satisfy themselves when bidding and at all times ensure that they can properly construct the work represented by these plans.

No Issued For Date 1 Issued for ZBA 2024-06-07

WALLMANARCHITECTS

99 Spadina Avenue, Suite 600 Toronto, Ontatrio M5V 3P8 t 416 340 1870 f 416 340 1871 www.wallmanarchitects.com

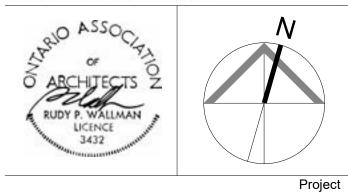

1050 Markham Road

1050 Markham Road, Toronto, Ontario, M1H 2Y5


CAPREIT

Client

Drawing Title

LEVEL 3 FLOOR PLAN

1 : 200	Scale
	Drawn by
	Checked by
23-11	Project No.
2024-06-07	Date
	Drawing No.

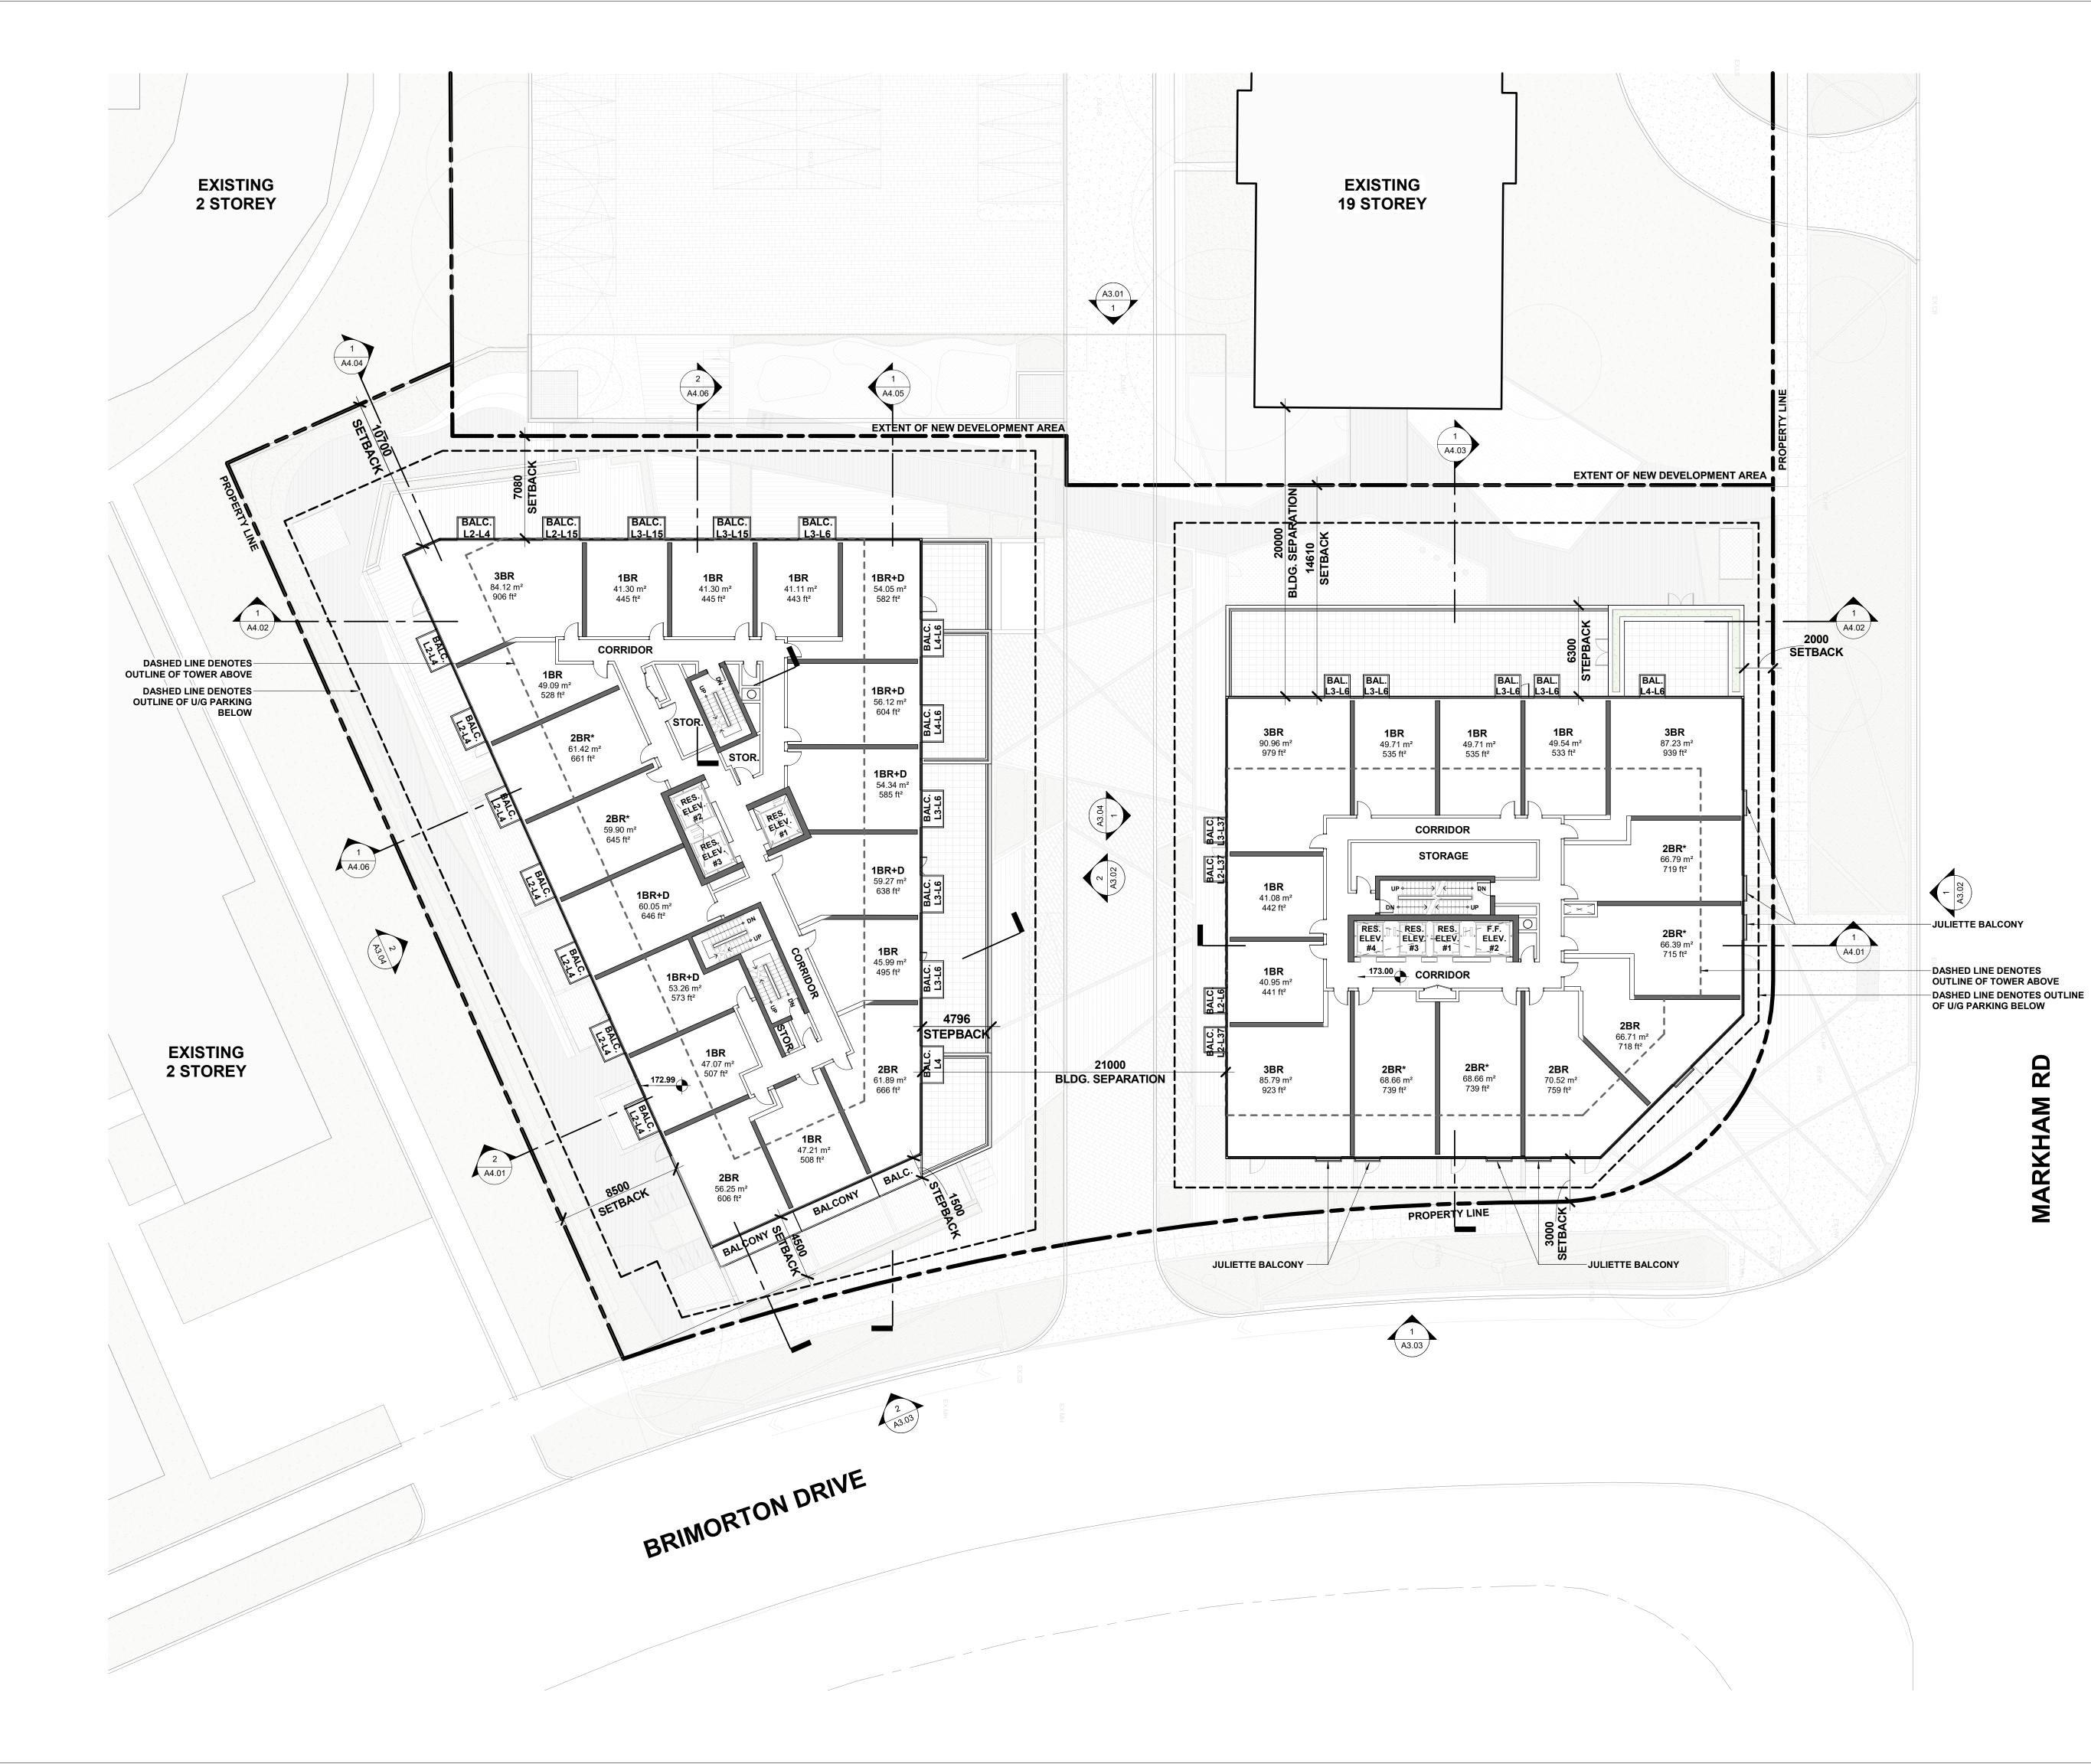

2. These Contract Documents are the property of the Architect. The Architect bears no responsibility for the interpretation of these documents by the Contractor. Upon written application the Architect will provide written/graphic clarification or supplementary information regarding the intent of the Contract Documents. The Architect will review Shop Drawings submitted by the Contractor for design conformance only.

3. Drawings are not to be scaled for construction. The Contractor is to verify all existing conditions and dimensions required to perform the work and report and discrepancies with the Contract Documents to the Architect before commencing any work.

4. Positions of exposed finishes for mechanical or electrical devised, fitting and fixtures are indicated on architectural drawings. The location shown on the architectural drawing govern over the mechanical and electrical drawings. Those items not clearly located will be located as directed by the Architect.

5. These drawings are not to be used for construction unless noted below as "Issued for Construction".

6. All work is to be carried out in conformance with the Code and Bylaws of the Authorities having jurisdiction.


7. The Architect of these plans and specifications gives no warranty or representation to any party about the constructability of the building(s) represented by them. All contractors or subcontractors must satisfy themselves when bidding and at all times ensure that they can properly construct the work represented by these plans.

 No
 Issued For
 Date

 1
 Issued for ZBA
 2024-06-07

WALLMANARCHITECTS

99 Spadina Avenue, Suite 600 Toronto, Ontatrio M5V 3P8 t 416 340 1870 f 416 340 1871 www.wallmanarchitects.com

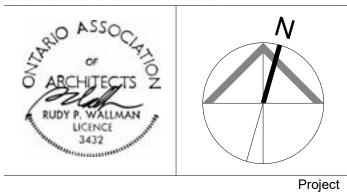

1050 Markham Road

1050 Markham Road, Toronto, Ontario, M1H 2Y5


CAPREIT

Client

Drawing Title

LEVEL 4 FLOOR PLAN

1 : 200	Scale
	Drawn by
	Checked by
23-11	Project No.
2024-06-07	Date
	Drawing No.

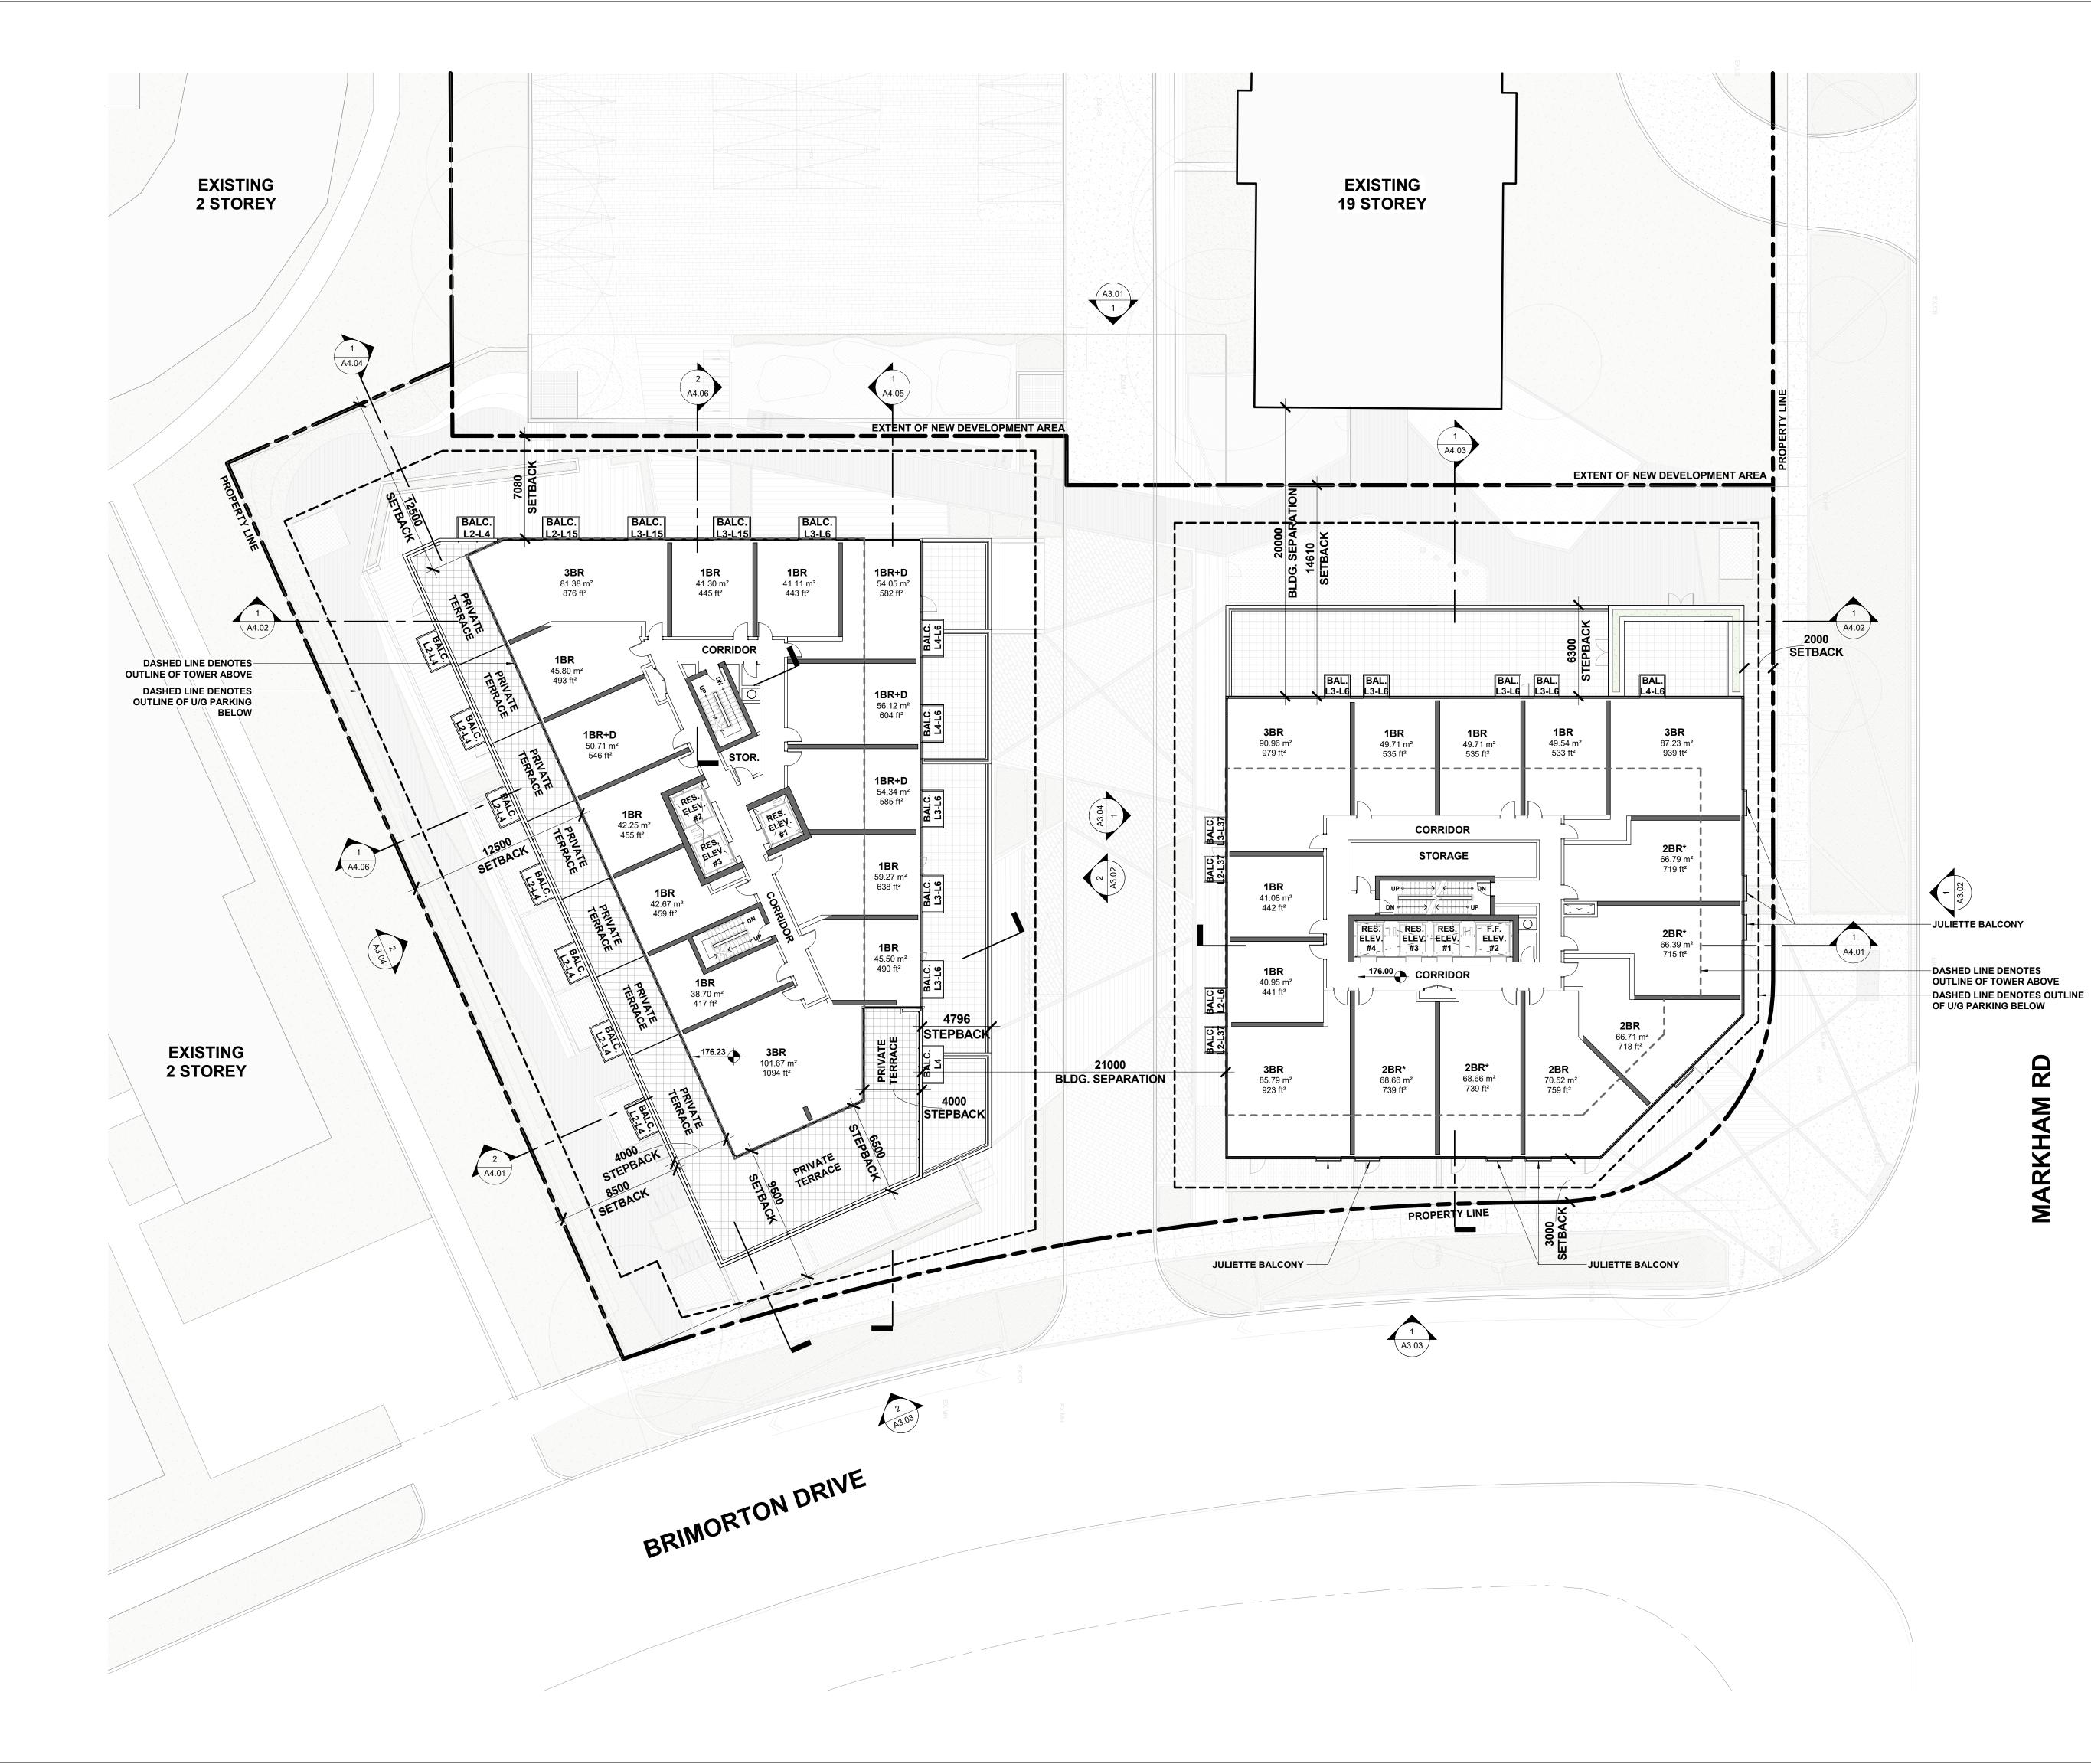

2. These Contract Documents are the property of the Architect. The Architect bears no responsibility for the interpretation of these documents by the Contractor. Upon written application the Architect will provide written/graphic clarification or supplementary information regarding the intent of the Contract Documents. The Architect will review Shop Drawings submitted by the Contractor for design conformance only.

3. Drawings are not to be scaled for construction. The Contractor is to verify all existing conditions and dimensions required to perform the work and report and discrepancies with the Contract Documents to the Architect before commencing any work.

4. Positions of exposed finishes for mechanical or electrical devised, fitting and fixtures are indicated on architectural drawings. The location shown on the architectural drawing govern over the mechanical and electrical drawings. Those items not clearly located will be located as directed by the Architect.

These drawings are not to be used for construction unless noted below as "Issued for Construction".

6. All work is to be carried out in conformance with the Code and Bylaws of the Authorities having jurisdiction.


7. The Architect of these plans and specifications gives no warranty or representation to any party about the constructability of the building(s) represented by them. All contractors or subcontractors must satisfy themselves when bidding and at all times ensure that they can properly construct the work represented by these plans.

 No
 Issued For
 Date

 1
 Issued for ZBA
 2024-06-07

WALLMANARCHITECTS

99 Spadina Avenue, Suite 600 Toronto, Ontatrio M5V 3P8 t 416 340 1870 f 416 340 1871 www.wallmanarchitects.com

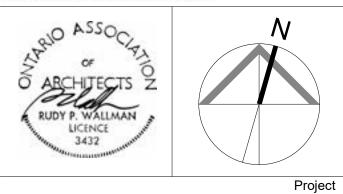

1050 Markham Road

1050 Markham Road, Toronto, Ontario, M1H 2Y5


Client

CAPREIT

Drawing Title

LEVEL 5 FLOOR PLAN

1 : 200	Scale
	Drawn by
	Checked by
23-11	Project No.
2024-06-07	Date
	Drawing No.

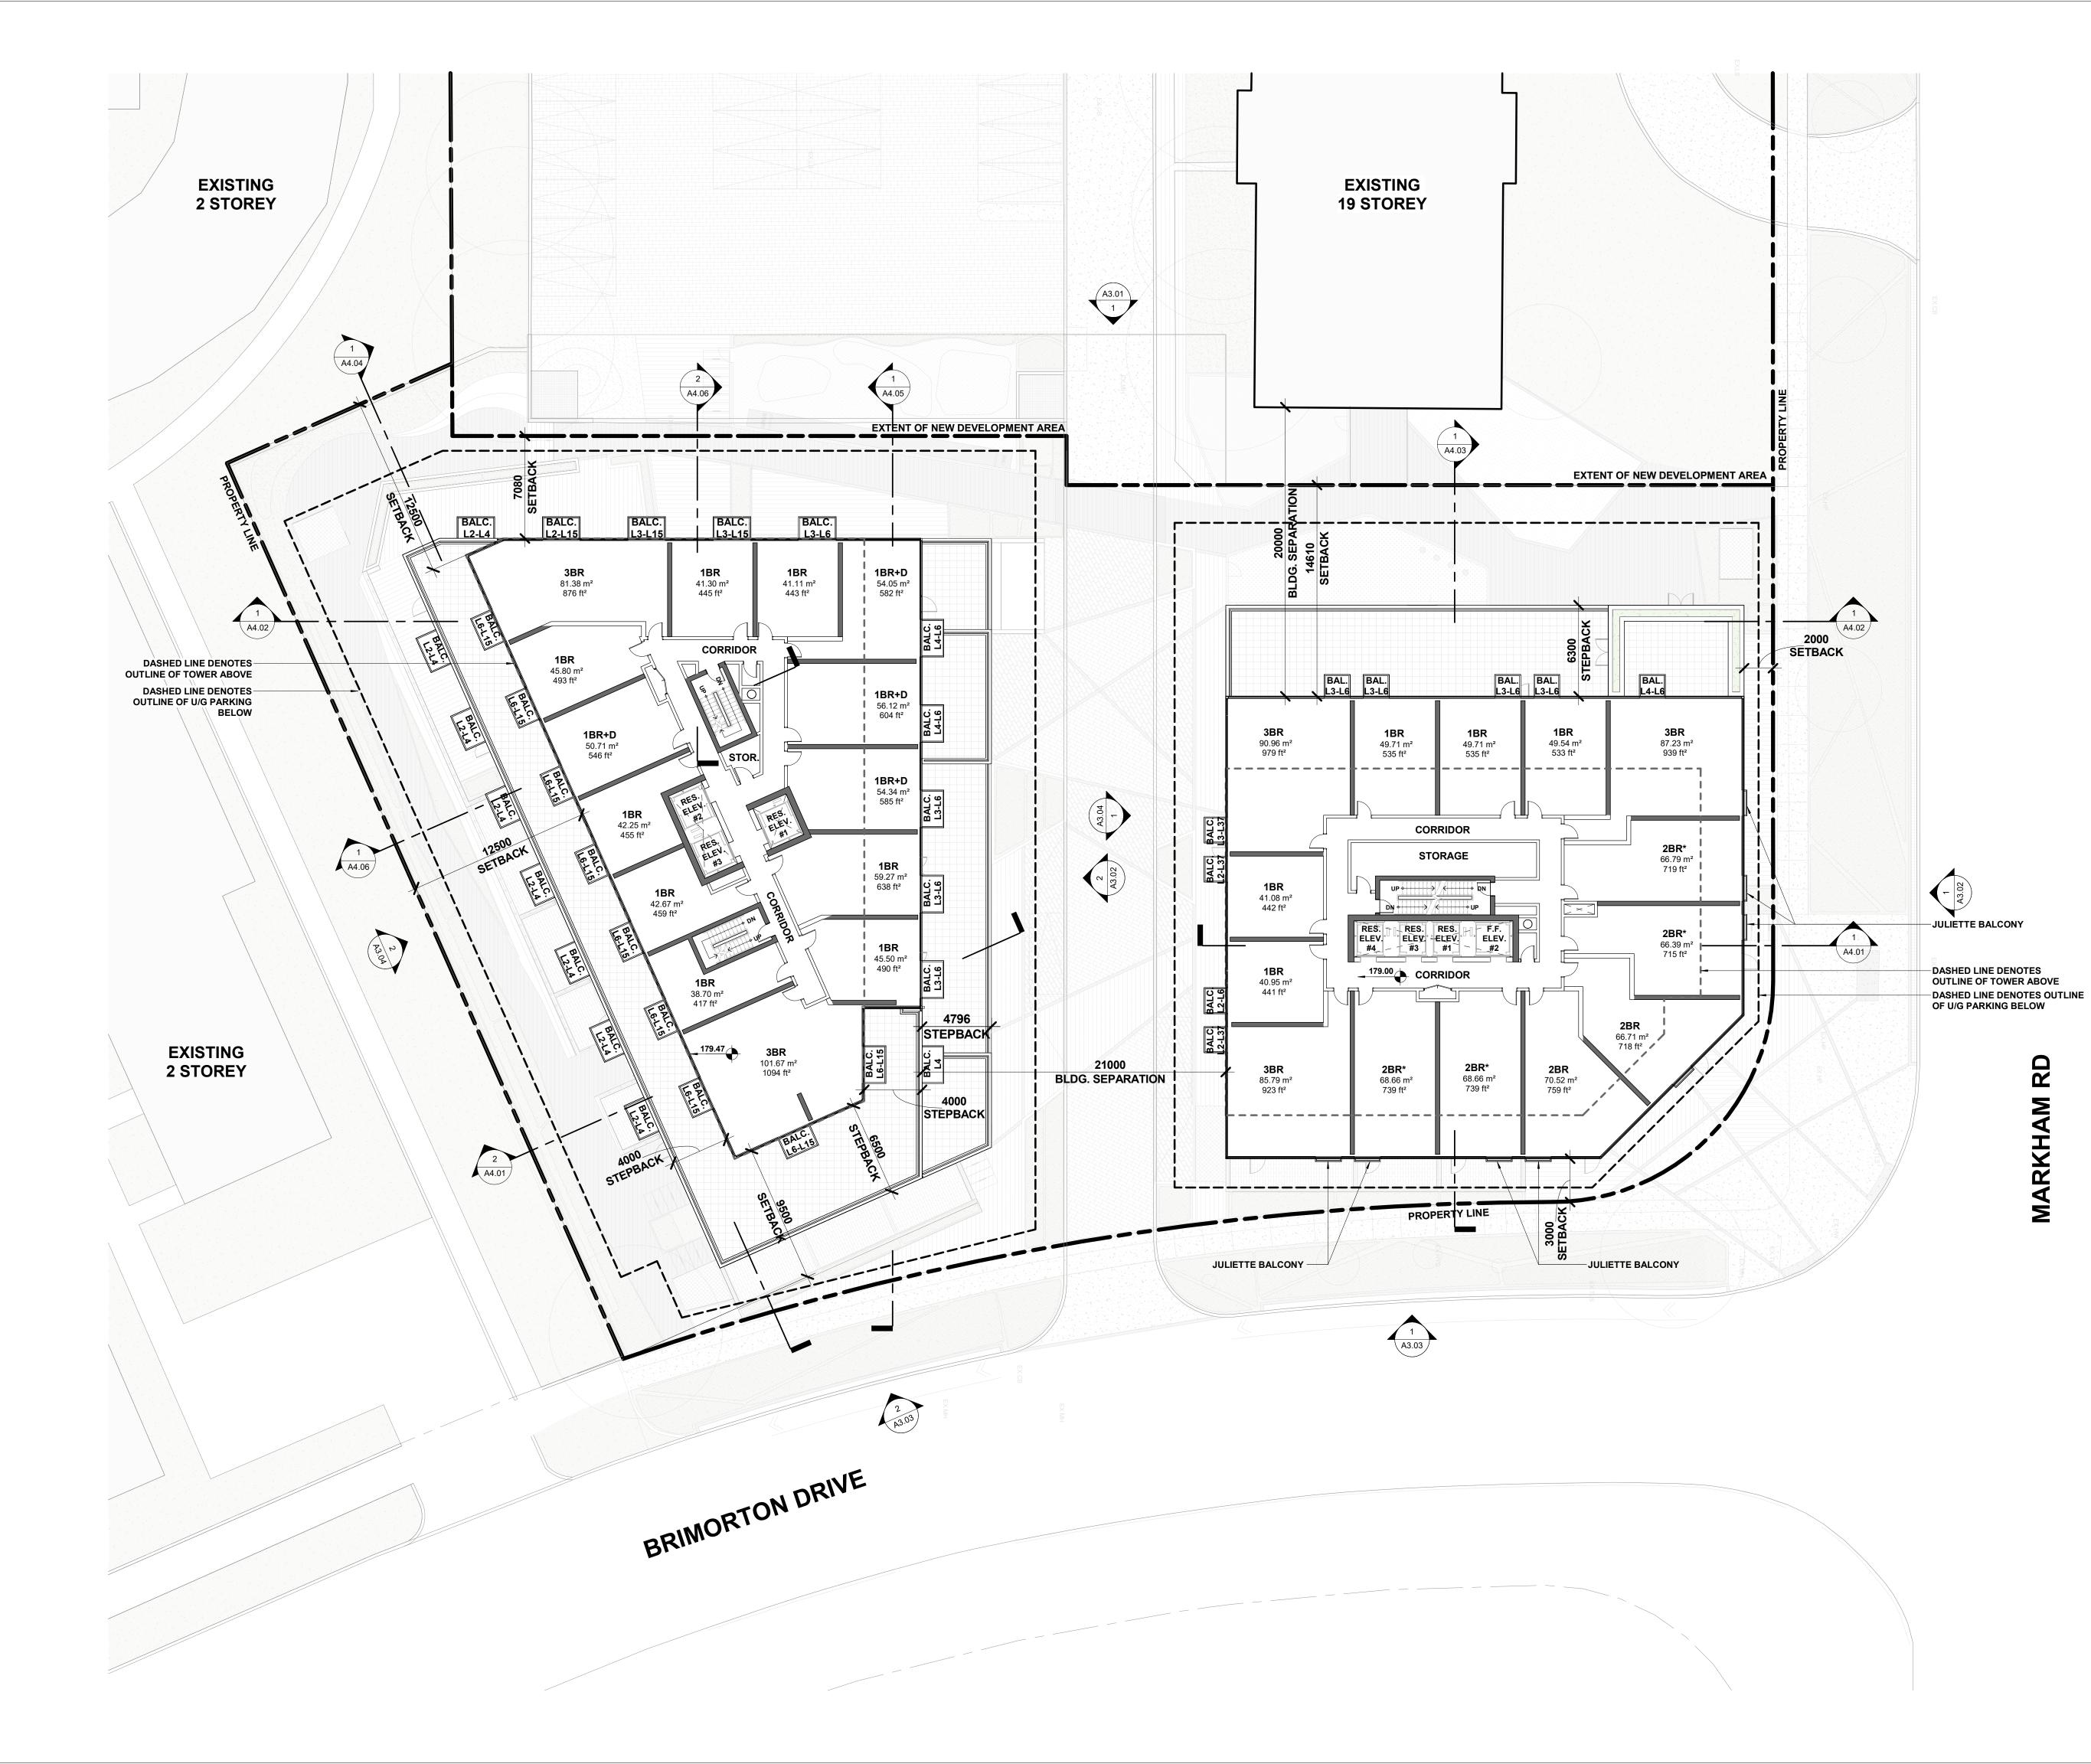

2. These Contract Documents are the property of the Architect. The Architect bears no responsibility for the interpretation of these documents by the Contractor. Upon written application the Architect will provide written/graphic clarification or supplementary information regarding the intent of the Contract Documents. The Architect will review Shop Drawings submitted by the Contractor for design conformance only.

3. Drawings are not to be scaled for construction. The Contractor is to verify all existing conditions and dimensions required to perform the work and report and discrepancies with the Contract Documents to the Architect before commencing any work.

4. Positions of exposed finishes for mechanical or electrical devised, fitting and fixtures are indicated on architectural drawings. The location shown on the architectural drawing govern over the mechanical and electrical drawings. Those items not clearly located will be located as directed by the Architect.

5. These drawings are not to be used for construction unless noted below as "Issued for Construction".

6. All work is to be carried out in conformance with the Code and Bylaws of the Authorities having jurisdiction.


7. The Architect of these plans and specifications gives no warranty or representation to any party about the constructability of the building(s) represented by them. All contractors or subcontractors must satisfy themselves when bidding and at all times ensure that they can properly construct the work represented by these plans.

 No
 Issued For
 Date

 1
 Issued for ZBA
 2024-06-07

WALLMANARCHITECTS

99 Spadina Avenue, Suite 600 Toronto, Ontatrio M5V 3P8 t 416 340 1870 f 416 340 1871 www.wallmanarchitects.com

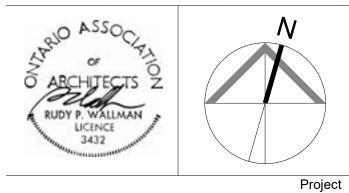

1050 Markham Road

1050 Markham Road, Toronto, Ontario, M1H 2Y5


CAPREIT

Client

Drawing Title

LEVEL 6 FLOOR PLAN

1 : 200	Scale
	Drawn by
	Checked by
23-11	Project No.
2024-06-07	Date
A2.11	Drawing No.

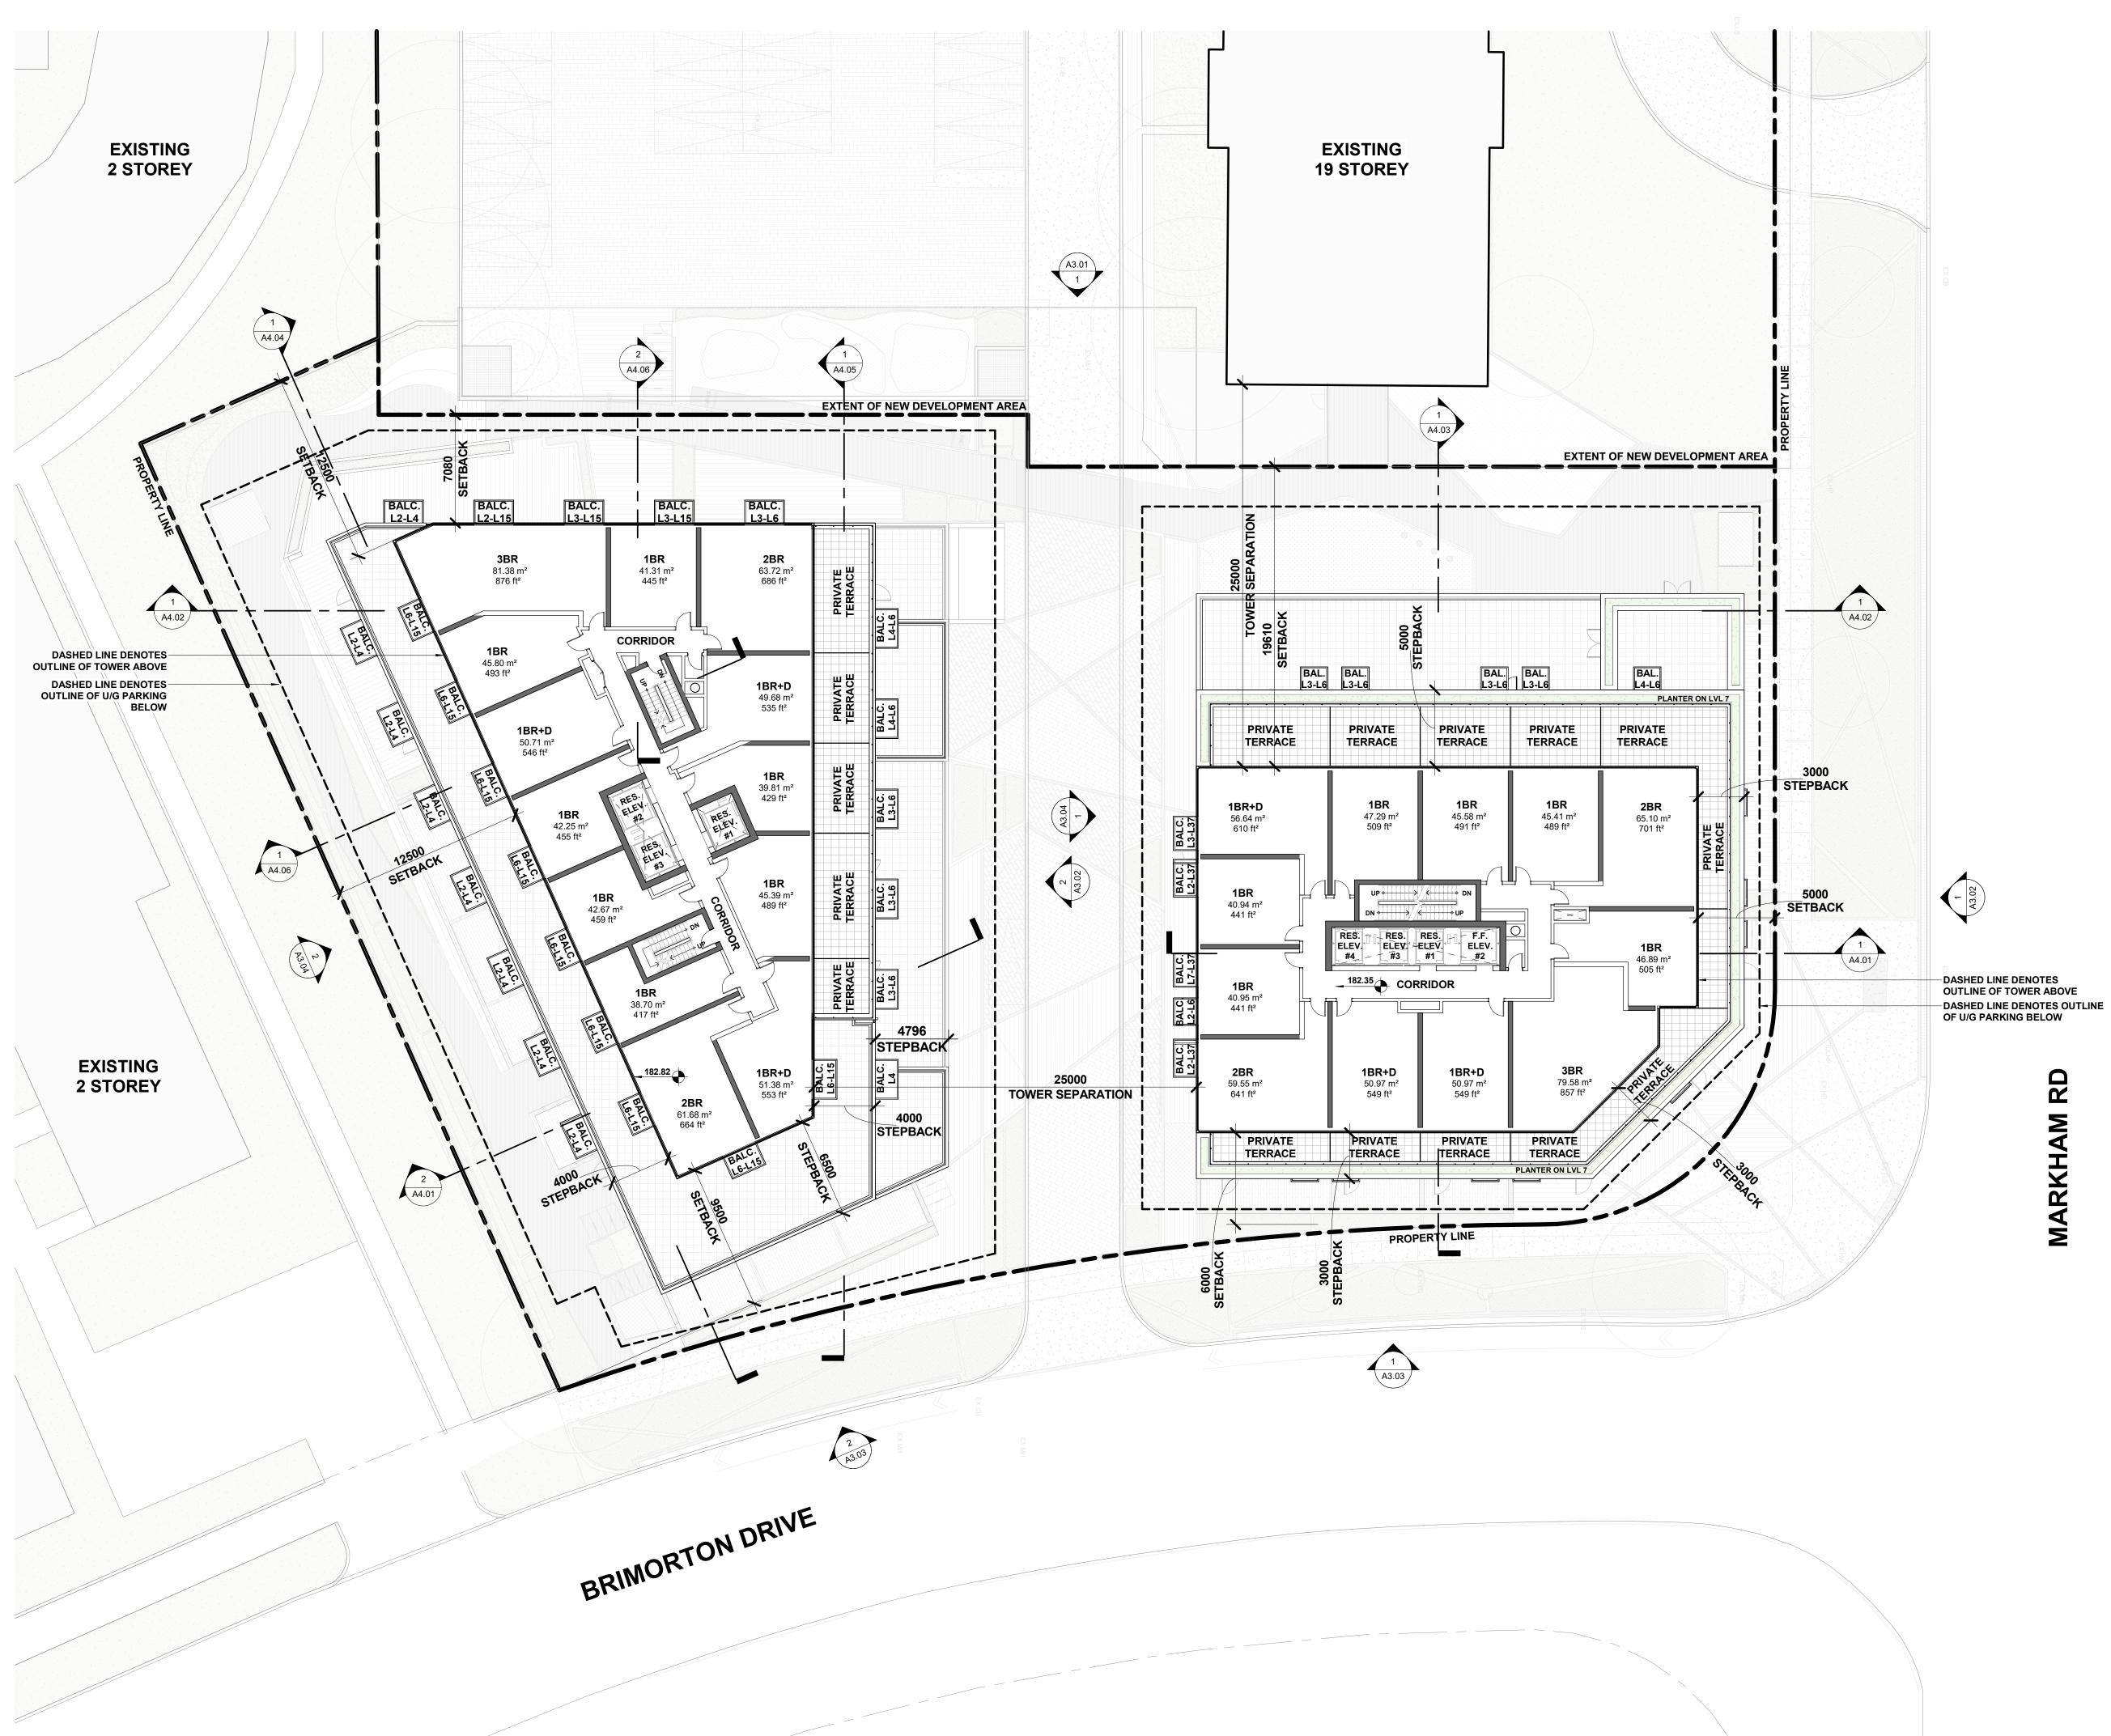

2. These Contract Documents are the property of the Architect. The Architect bears no responsibility for the interpretation of these documents by the Contractor. Upon written application the Architect will provide written/graphic clarification or supplementary information regarding the intent of the Contract Documents. The Architect will review Shop Drawings submitted by the Contractor for design conformance only.

3. Drawings are not to be scaled for construction. The Contractor is to verify all existing conditions and dimensions required to perform the work and report and discrepancies with the Contract Documents to the Architect before commencing any work.

4. Positions of exposed finishes for mechanical or electrical devised, fitting and fixtures are indicated on architectural drawings. The location shown on the architectural drawing govern over the mechanical and electrical drawings. Those items not clearly located will be located as directed by the Architect.

5. These drawings are not to be used for construction unless noted below as "Issued for Construction".


6. All work is to be carried out in conformance with the Code and Bylaws of the Authorities having jurisdiction.

7. The Architect of these plans and specifications gives no warranty or representation to any party about the constructability of the building(s) represented by them. All contractors or subcontractors must satisfy themselves when bidding and at all times ensure that they can properly construct the work represented by these plans.

No Issued For Date 2024-06-07 1 Issued for ZBA

WALLMANARCHITECTS

99 Spadina Avenue, Suite 600 Toronto, Ontatrio M5V 3P8 t 416 340 1870 f 416 340 1871 www.wallmanarchitects.com

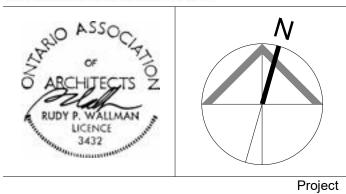

1050 Markham Road

1050 Markham Road, Toronto, Ontario, M1H 2Y5

Client

CAPREIT

RD


 \geq

MARKH

Drawing Title

LEVEL 7 FLOOR PLAN

1 : 200	Scale
	Drawn by
	Checked by
23-11	Project No.
2024-06-07	Date
	Drawing No.

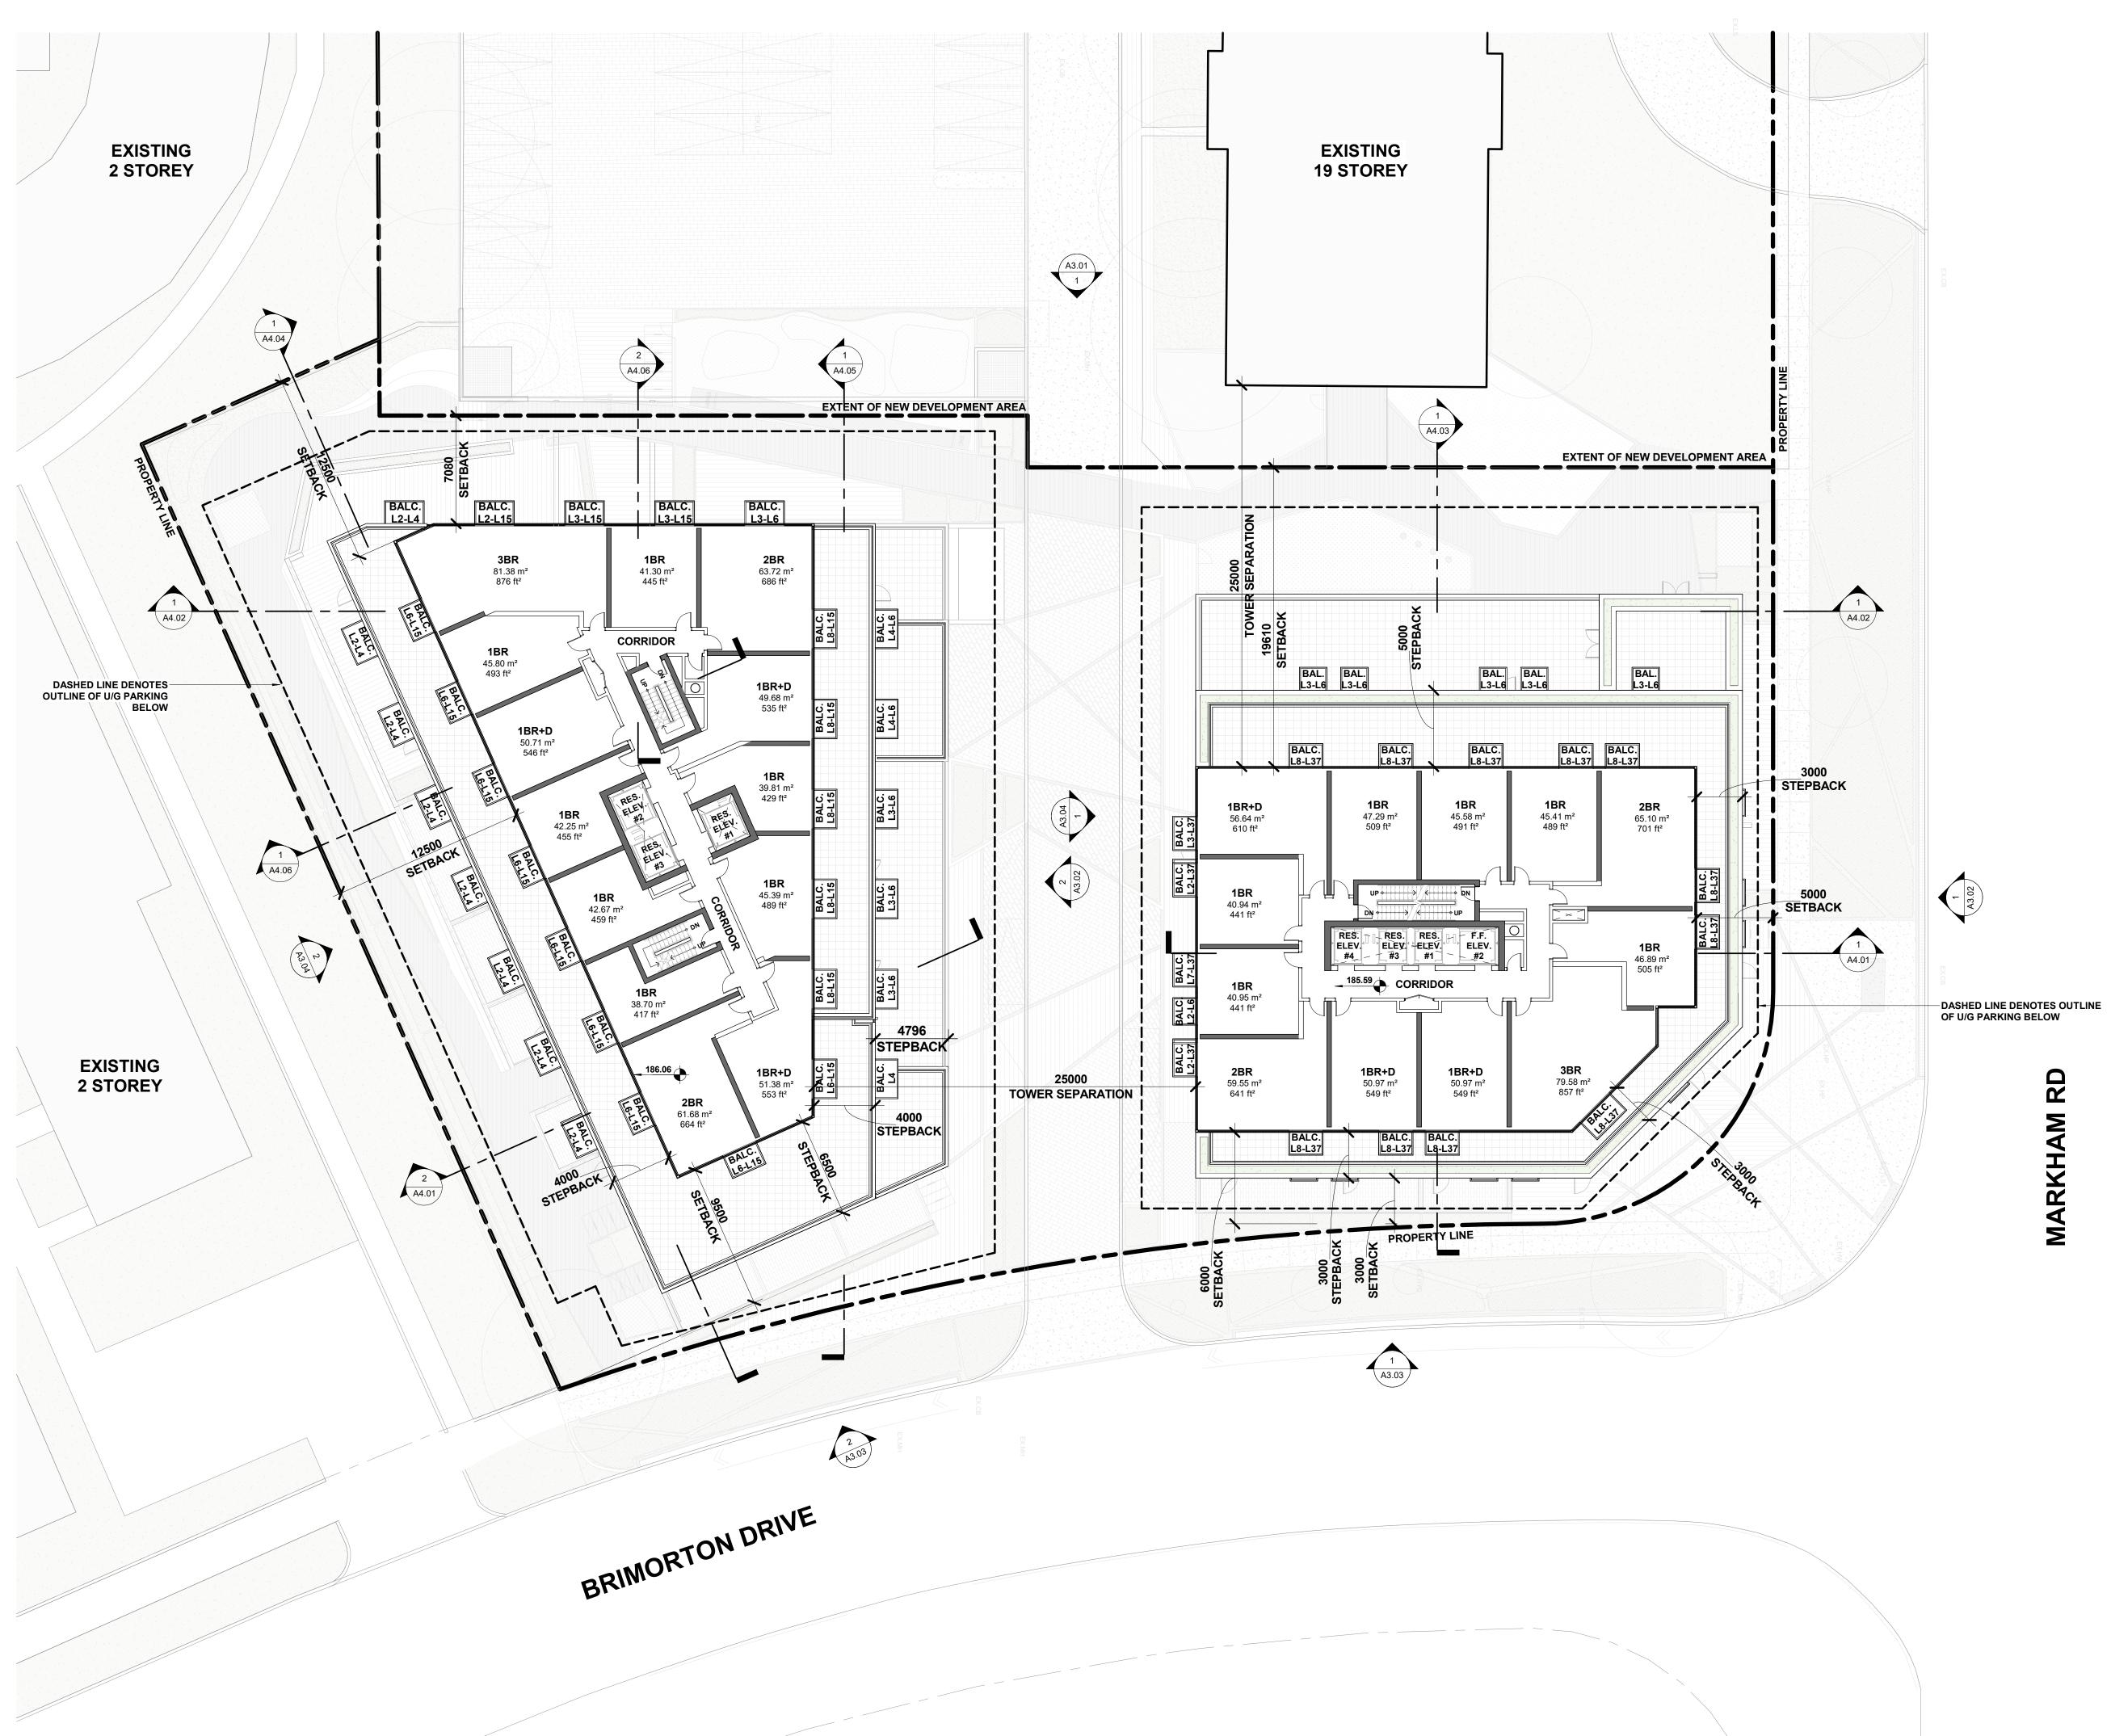

2. These Contract Documents are the property of the Architect. The Architect bears no responsibility for the interpretation of these documents by the Contractor. Upon written application the Architect will provide written/graphic clarification or supplementary information regarding the intent of the Contract Documents. The Architect will review Shop Drawings submitted by the Contractor for design conformance only.

3. Drawings are not to be scaled for construction. The Contractor is to verify all existing conditions and dimensions required to perform the work and report and discrepancies with the Contract Documents to the Architect before commencing any work.

4. Positions of exposed finishes for mechanical or electrical devised, fitting and fixtures are indicated on architectural drawings. The location shown on the architectural drawing govern over the mechanical and electrical drawings. Those items not clearly located will be located as directed by the Architect.

5. These drawings are not to be used for construction unless noted below as "Issued for Construction".


6. All work is to be carried out in conformance with the Code and Bylaws of the Authorities having jurisdiction.

7. The Architect of these plans and specifications gives no warranty or representation to any party about the constructability of the building(s) represented by them. All contractors or subcontractors must satisfy themselves when bidding and at all times ensure that they can properly construct the work represented by these plans.

No Issued For Date 2024-06-07 1 Issued for ZBA

WALLMANARCHITECTS

99 Spadina Avenue, Suite 600 Toronto, Ontatrio M5V 3P8 t 416 340 1870 f 416 340 1871 www.wallmanarchitects.com

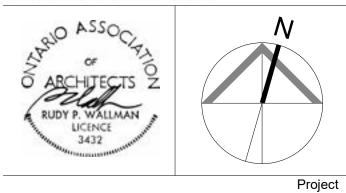

1050 Markham Road

1050 Markham Road, Toronto, Ontario, M1H 2Y5

CAPREIT

RD

Σ

MARKH

Client

Drawing Title

OVERALL TYPICAL TOWER FLOOR PLAN

BUILDING 'A' - FLOORS 8 - 37 BUILDING 'B' - FLOORS 8 - 15


Scale 1 : 200 Drawn by Checked by Project No. 23-11

2024-06-07

A2.13

Drawing No.

Date

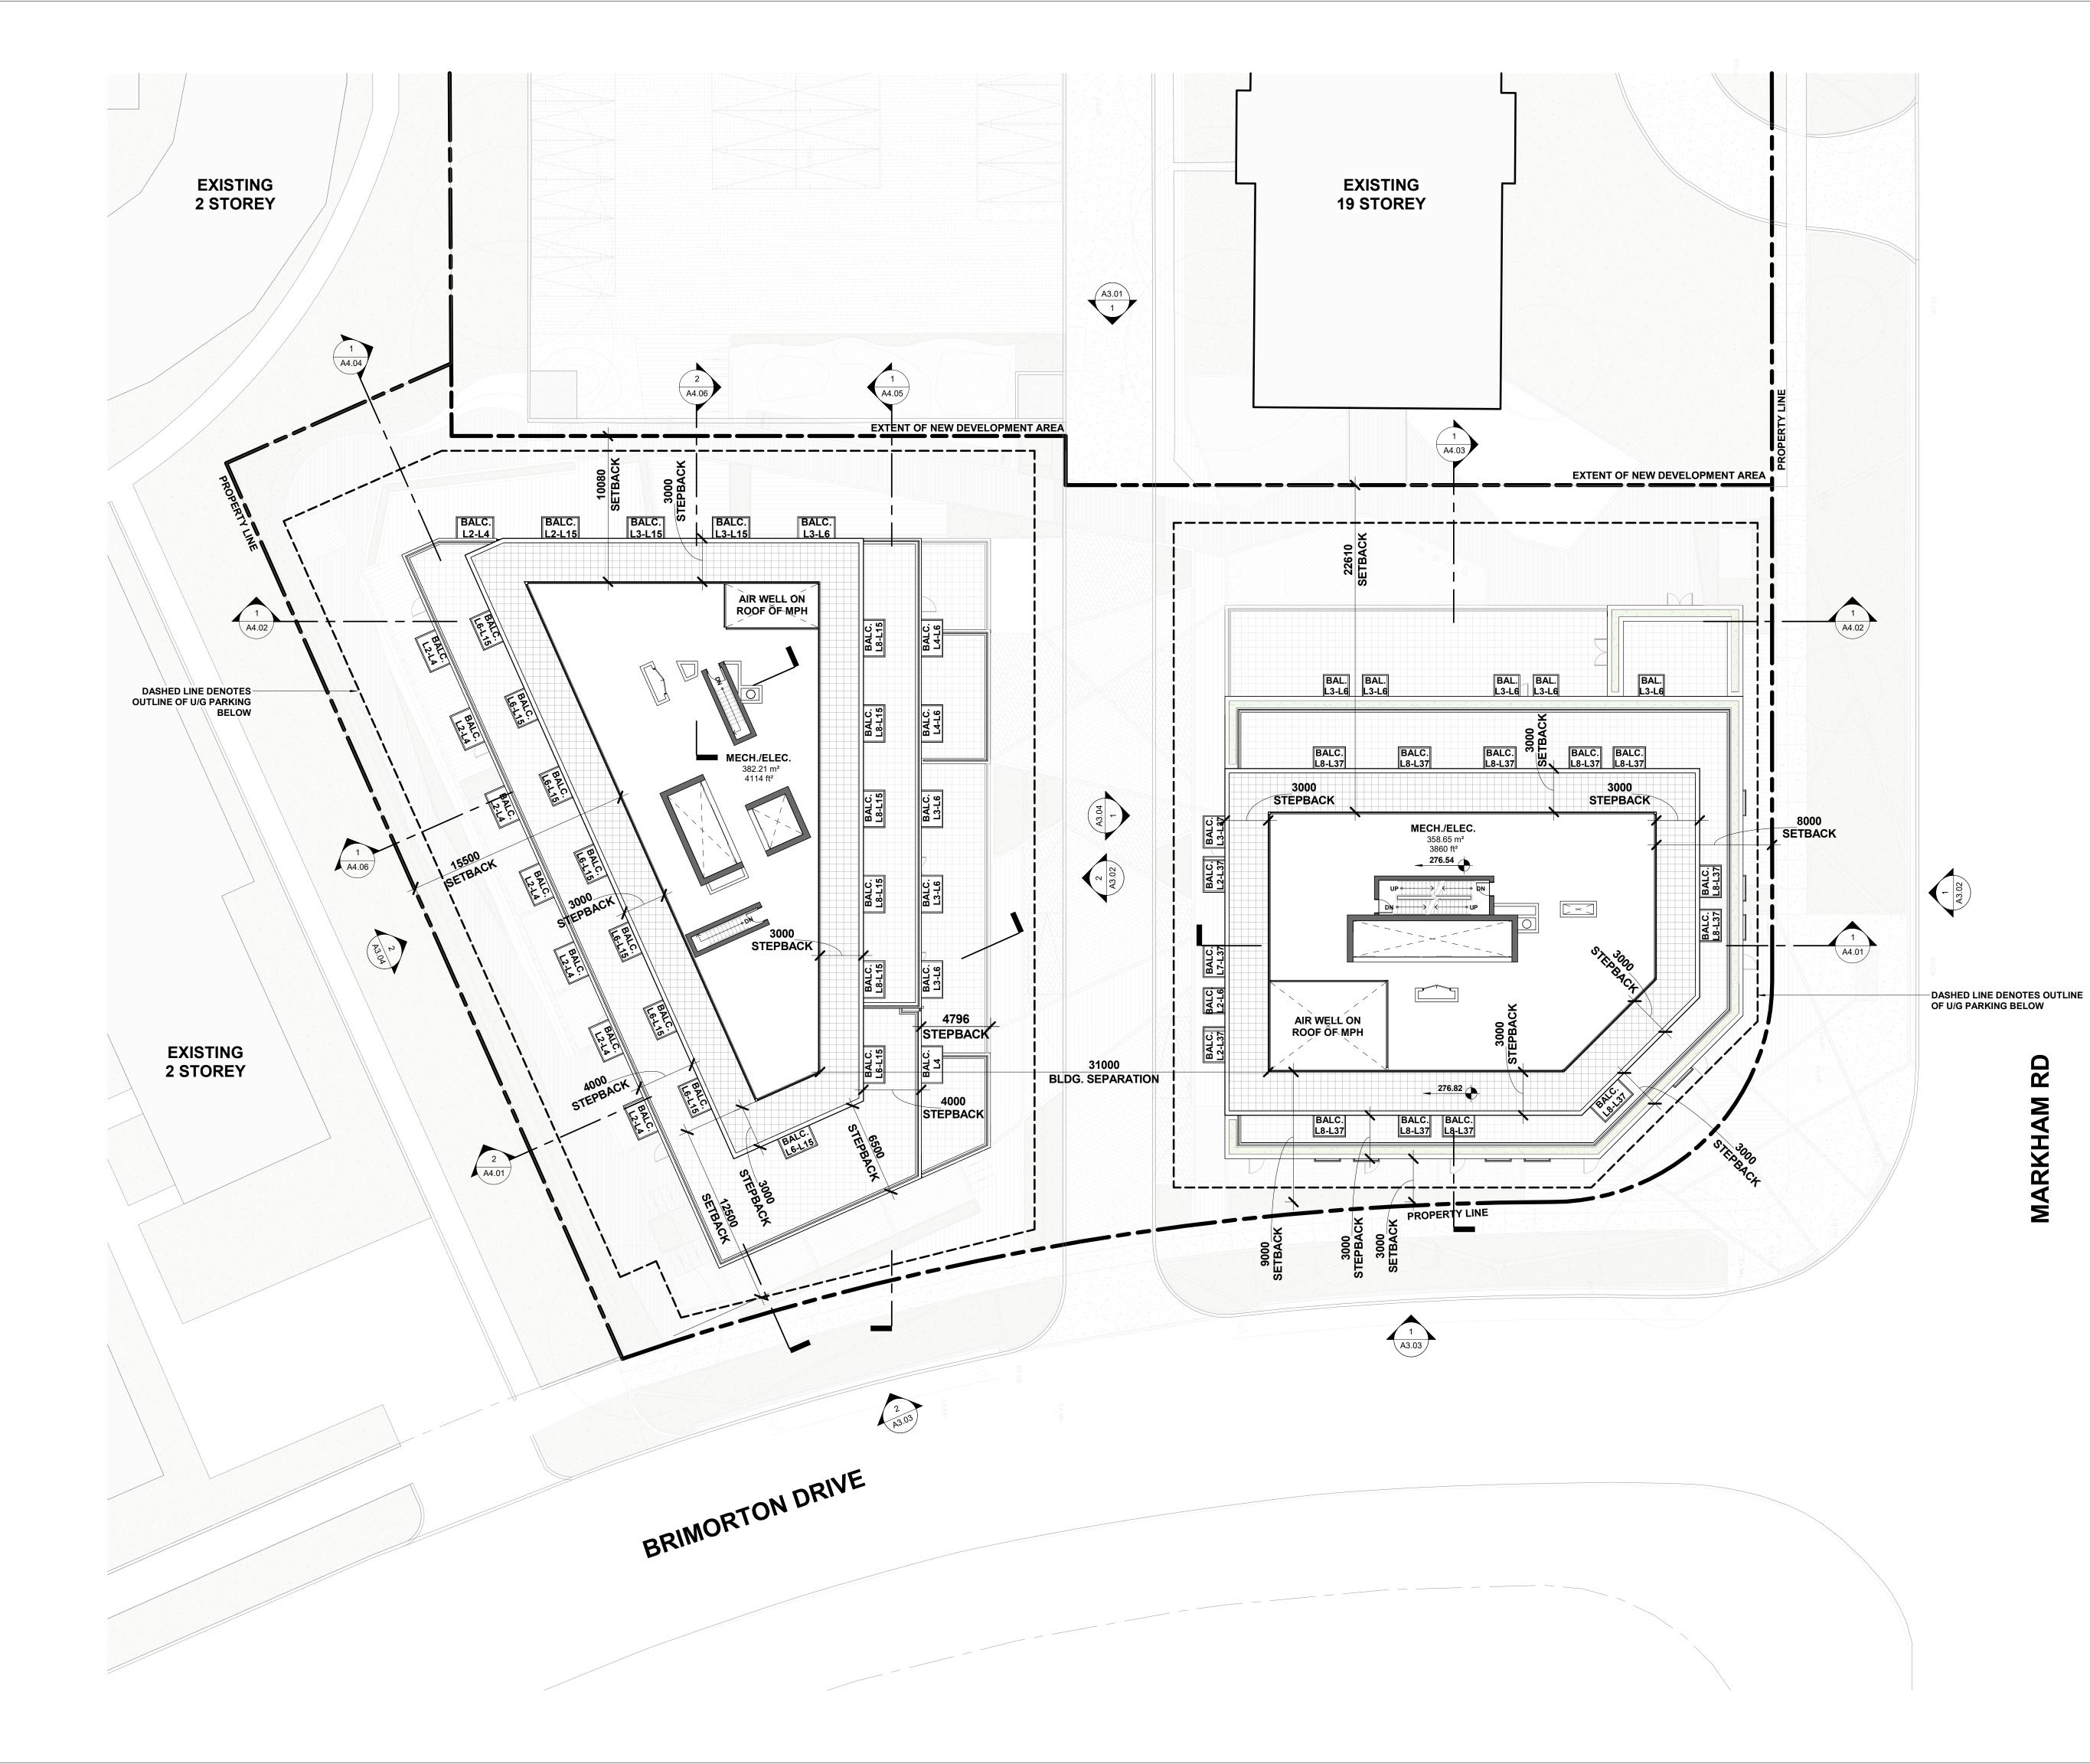

2. These Contract Documents are the property of the Architect. The Architect bears no responsibility for the interpretation of these documents by the Contractor. Upon written application the Architect will provide written/graphic clarification or supplementary information regarding the intent of the Contract Documents. The Architect will review Shop Drawings submitted by the Contractor for design conformance only.

3. Drawings are not to be scaled for construction. The Contractor is to verify all existing conditions and dimensions required to perform the work and report and discrepancies with the Contract Documents to the Architect before commencing any work.

4. Positions of exposed finishes for mechanical or electrical devised, fitting and fixtures are indicated on architectural drawings. The location shown on the architectural drawing govern over the mechanical and electrical drawings. Those items not clearly located will be located as directed by the Architect.

5. These drawings are not to be used for construction unless noted below as "Issued for Construction".

6. All work is to be carried out in conformance with the Code and Bylaws of the Authorities having jurisdiction.


7. The Architect of these plans and specifications gives no warranty or representation to any party about the constructability of the building(s) represented by them. All contractors or subcontractors must satisfy themselves when bidding and at all times ensure that they can properly construct the work represented by these plans.

 No
 Issued For
 Date

 1
 Issued for ZBA
 2024-06-07

WALLMANARCHITECTS

99 Spadina Avenue, Suite 600 Toronto, Ontatrio M5V 3P8 t 416 340 1870 f 416 340 1871 www.wallmanarchitects.com

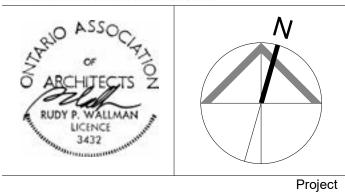

1050 Markham Road

1050 Markham Road, Toronto, Ontario, M1H 2Y5


CAPREIT

Client

Drawing Title

MECHANICAL PENTHOUSE

1 : 200	Scale
	Drawn by
	Checked by
23-11	Project No.
2024-06-07	Date
	Drawing No.

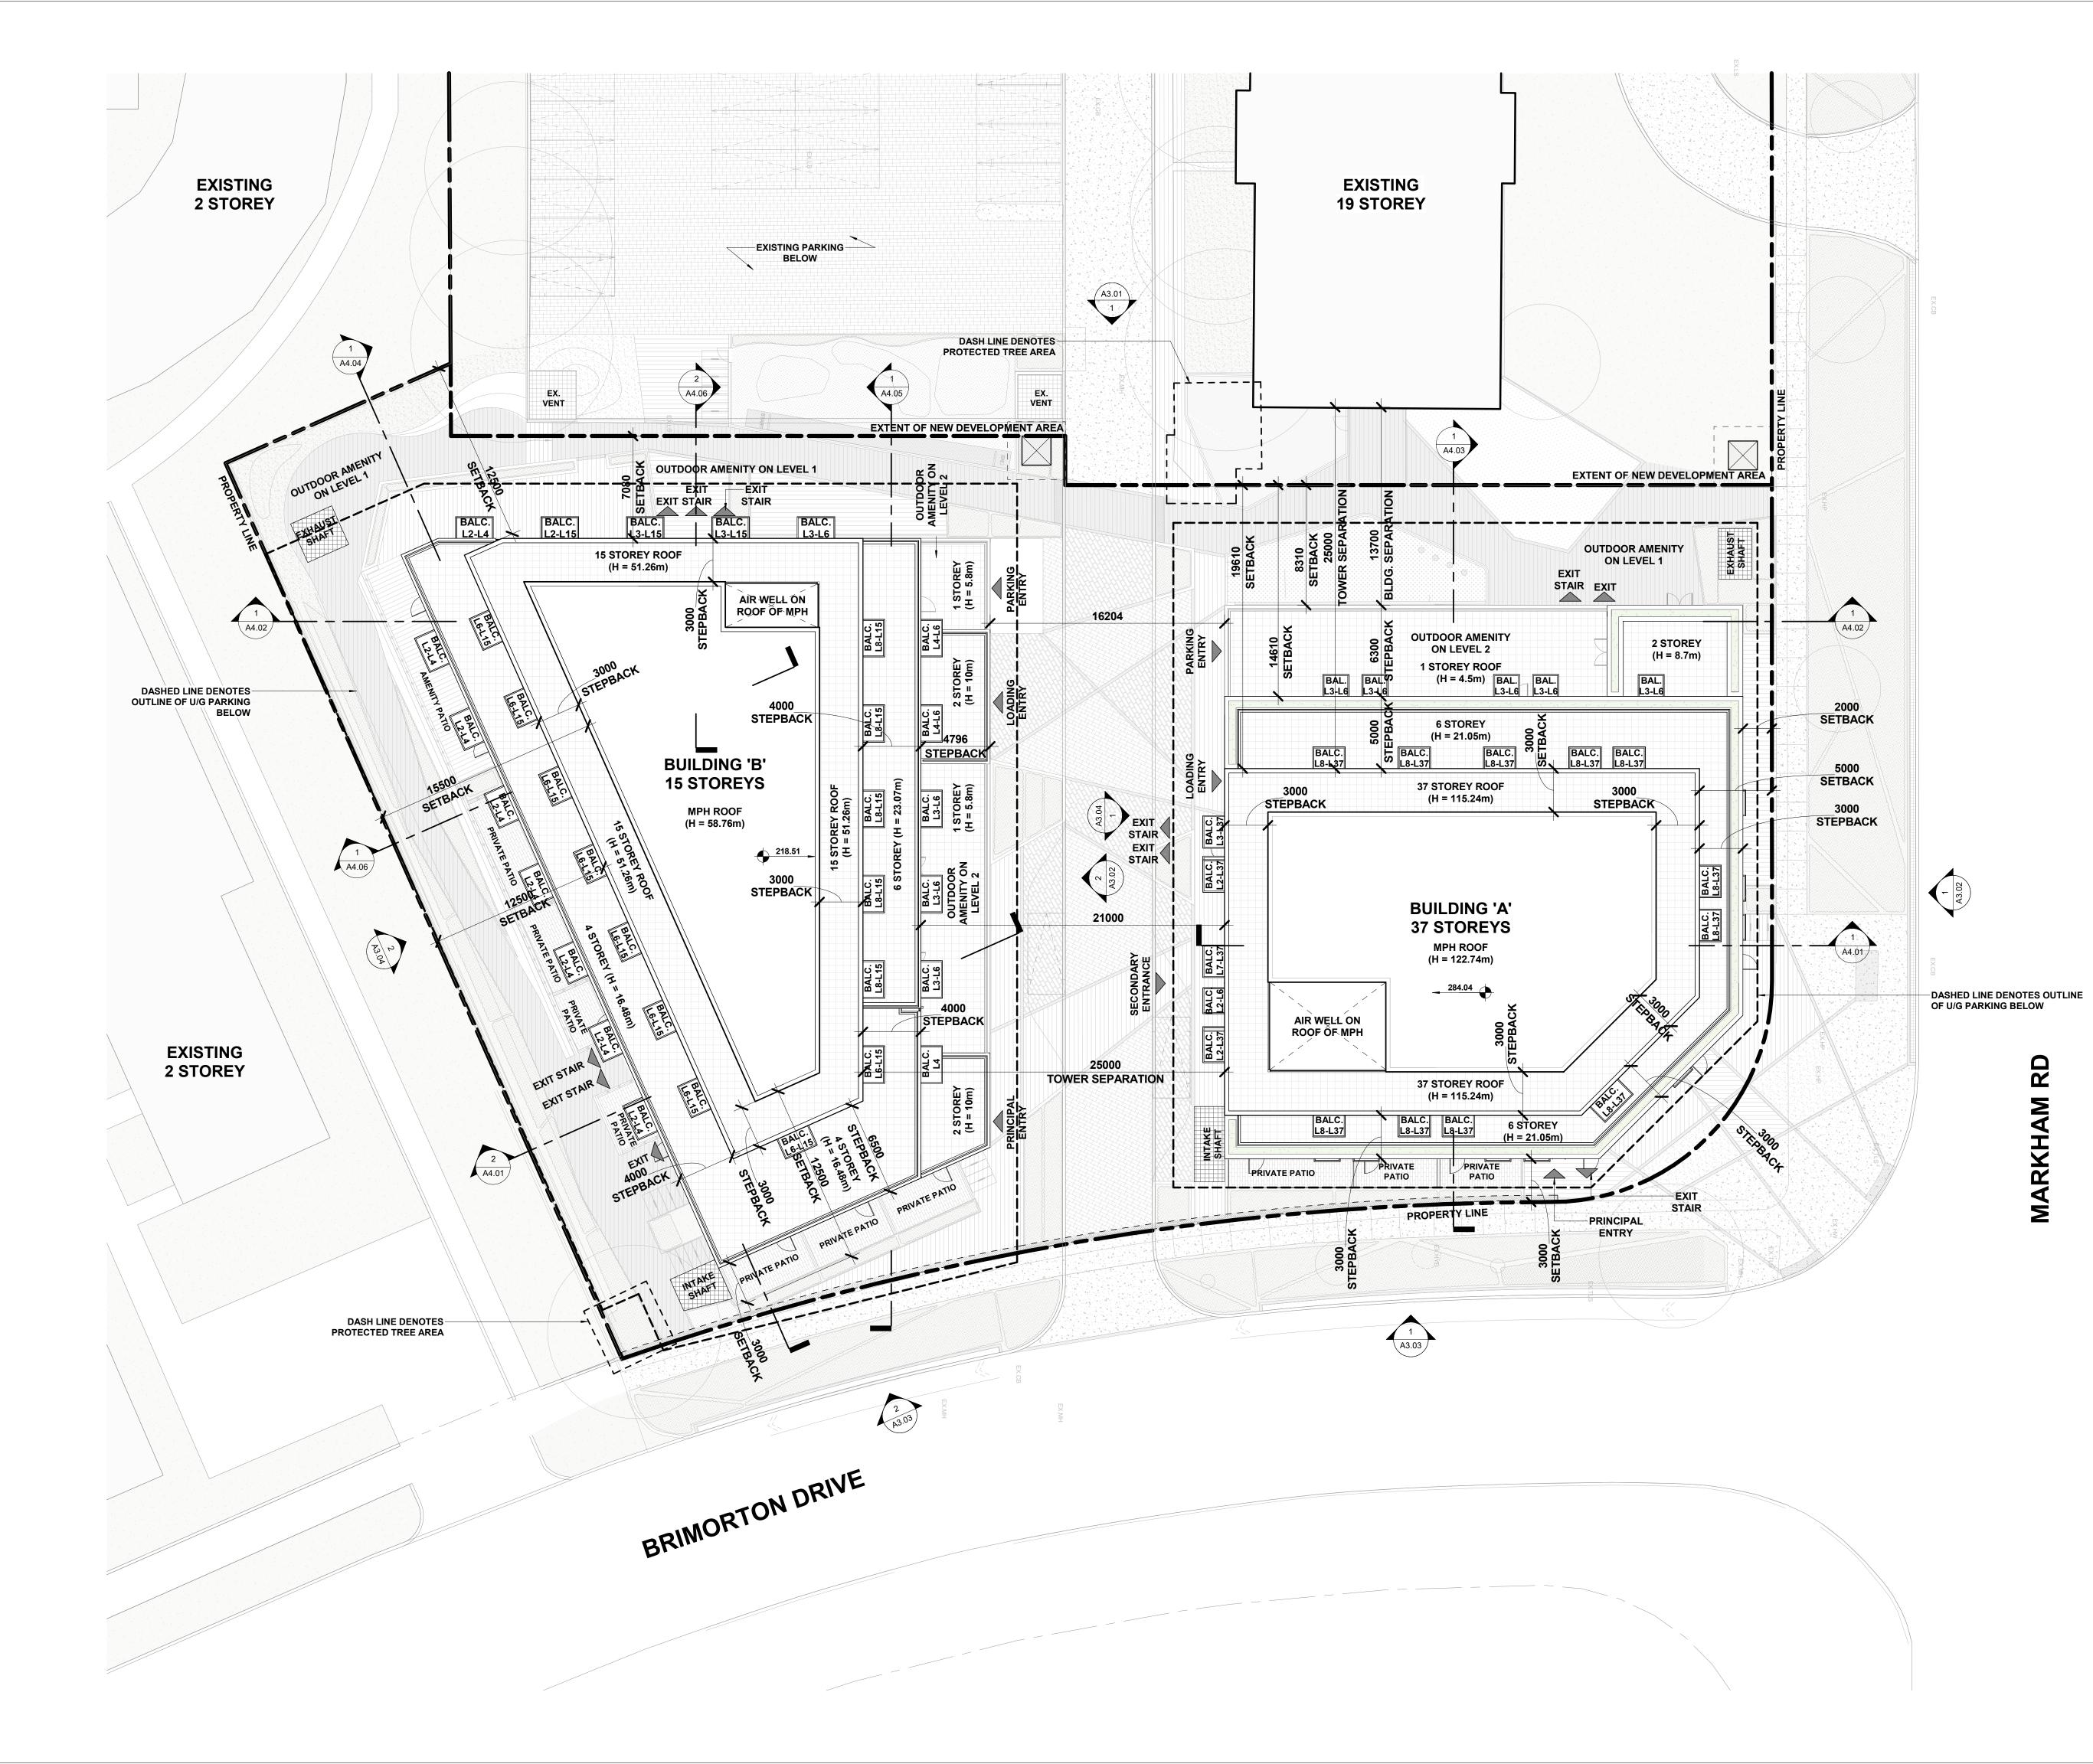

2. These Contract Documents are the property of the Architect. The Architect bears no responsibility for the interpretation of these documents by the Contractor. Upon written application the Architect will provide written/graphic clarification or supplementary information regarding the intent of the Contract Documents. The Architect will review Shop Drawings submitted by the Contractor for design conformance only.

3. Drawings are not to be scaled for construction. The Contractor is to verify all existing conditions and dimensions required to perform the work and report and discrepancies with the Contract Documents to the Architect before commencing any work.

4. Positions of exposed finishes for mechanical or electrical devised, fitting and fixtures are indicated on architectural drawings. The location shown on the architectural drawing govern over the mechanical and electrical drawings. Those items not clearly located will be located as directed by the Architect.

5. These drawings are not to be used for construction unless noted below as "Issued for Construction".


All work is to be carried out in conformance with the Code and Bylaws of the Authorities having jurisdiction.

7. The Architect of these plans and specifications gives no warranty or representation to any party about the constructability of the building(s) represented by them. All contractors or subcontractors must satisfy themselves when bidding and at all times ensure that they can properly construct the work represented by these plans.

No Issued For Date 2024-06-07 1 Issued for ZBA

WALLMANARCHITECTS

99 Spadina Avenue, Suite 600 Toronto, Ontatrio M5V 3P8 t 416 340 1870 f 416 340 1871 www.wallmanarchitects.com

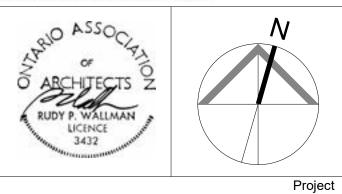

1050 Markham Road

1050 Markham Road, Toronto, Ontario, M1H 2Y5

CAPREIT

RD


>

MARKH.

Client


Drawing Title

ROOF PLAN

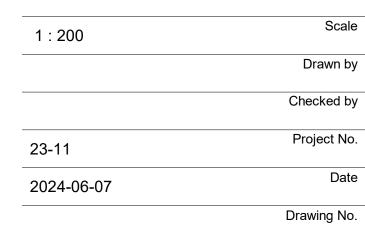

		т	5000 OWER SETBACK	
284.04 TWR A - T.O. MPH		↓		
	7500	HdW		
276.54 TWR A - MPH				
272.59 TWR A - LVL 37	3820 3820 0			
269.59 TWR A - LVL 36				╶╾╴ ╼╼╴╼╼
266.59 TWR A - LVL 35			-i	
263.59 TWR A - LVL 34				
260.59 TWR A - LVL 33			i 📑	
257.59 TWR A - LVL 32				
254.59 TWR A - LVL 31	300 30	<u> </u>		
251.59 TWR A - LVL 30	300 30			
248.59 TWR A - LVL 29	300 300 300 300 300 300 300 300 300 300			
245.59 TWR A - LVL 28	300			
242.59 TWR A - LVL 27				
239.59 TWR A - LVL 26				
236.59 TWR A - LVL 25				
233.59 TWR A - LVL 24				
230.59 TWR A - LVL 23				
227.59 TWR A - LVL 22		<u> </u>		
224.59 TWR A - LVL 21	15240 NG HEI			
221.59 TWR A - LVL 20 218.59 TWR A - LVL 19	115240 115240 BUILDING HEIGHT			
215.59 TWR A - LVL 18				ΠĦ
212.59 TWR A - LVL 17				Π
209.59 TWR A - LVL 16				Π
206.59 TWR A - LVL 15				THE I
203.59 TWR A - LVL 14				中田
200.59 TWR A - LVL 13	3000			
197.59 TWR A - LVL 12				$\blacksquare \blacksquare \blacksquare$
194.59 TWR A - LVL 11				
191.59 TWR A - LVL 10				
188.59 TWR A - LVL 09	A ROAL			
185.59 TWR A - LVL 08	MARKHAM ROAD	★		
182.35 TWR A - LVL 07	OF MAR 3240			
179.00 BLD A - LVL 06	3355			ΠΠΕ
176.00 BLD A - LVL 05	3000	ЭНТ ЗНТ LIMITS	-i 🗓 - 🖸	
173.00 BLD A - LVL 04				
170.00 BLD A - LVL 03		21050 21050 16000 LY GLAZIN		
165.80 BLD A - LVL 02	4300 4300	210 210 PODIUM 16000		
161.30 BLD A - LVL 01	4 7200		NT	T



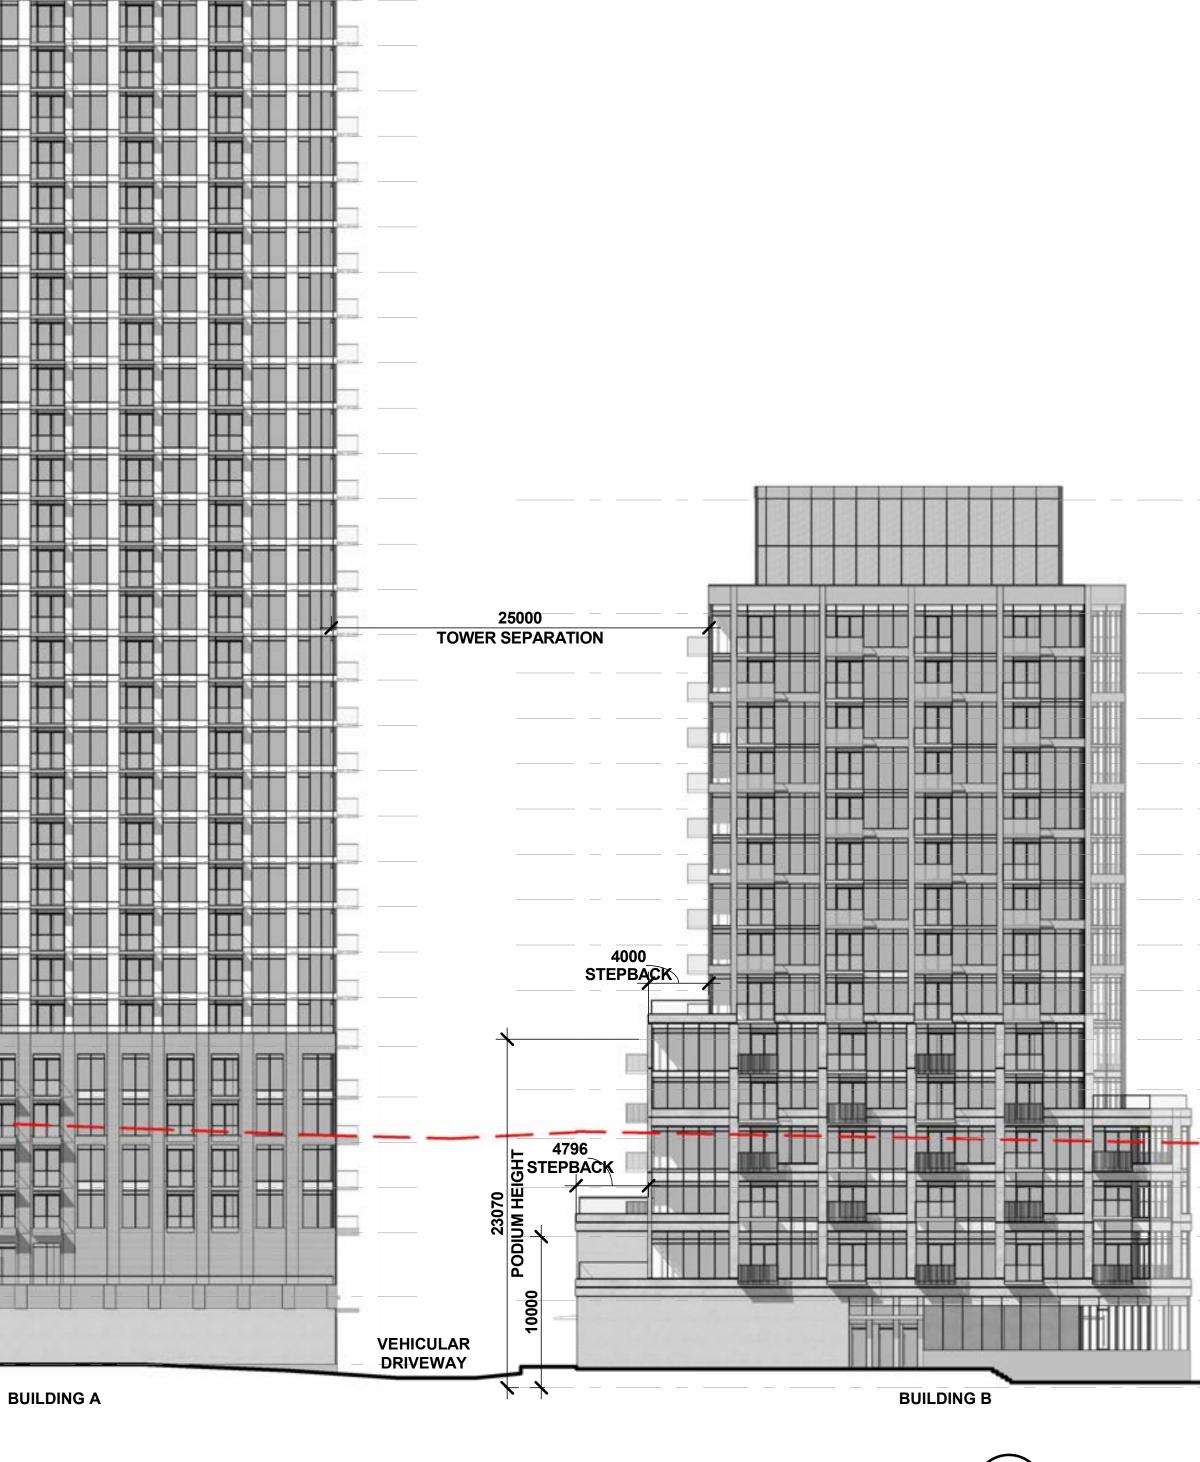

_

1. Copyright of this drawing is reserved by the Architect. The drawing, and all associated documents are instruments of service by the Architect. The drawing, and the information contained therein, may not be reproduced in whole or in part without prior written permission of the Architect.

2. These Contract Documents are the property of the Architect. The Architect bears no responsibility for the interpretation of these documents by the Contractor. Upon written application the Architect will provide written/graphic clarification or supplementary information regarding the intent of the Contract Documents. The Architect will review Shop Drawings submitted by the Contractor for design conformance only.

3. Drawings are not to be scaled for construction. The Contractor is to verify all existing conditions and dimensions required to perform the work and report and discrepancies with the Contract Documents to the Architect before commencing any work.


4. Positions of exposed finishes for mechanical or electrical devised, fitting and fixtures are indicated on architectural drawings. The location shown on the architectural drawing govern over the mechanical and electrical drawings. Those items not clearly located will be located as directed by the Architect.

5. These drawings are not to be used for construction unless noted below as "Issued for Construction".

All work is to be carried out in conformance with the Code and Bylaws of the Authorities having jurisdiction.

7. The Architect of these plans and specifications gives no warranty or representation to any party about the constructability of the building(s) represented by them. All contractors or subcontractors must satisfy themselves when bidding and at all times ensure that they can properly construct the work represented by these plans.

Date No Issued For 2024-06-07 1 Issued for ZBA

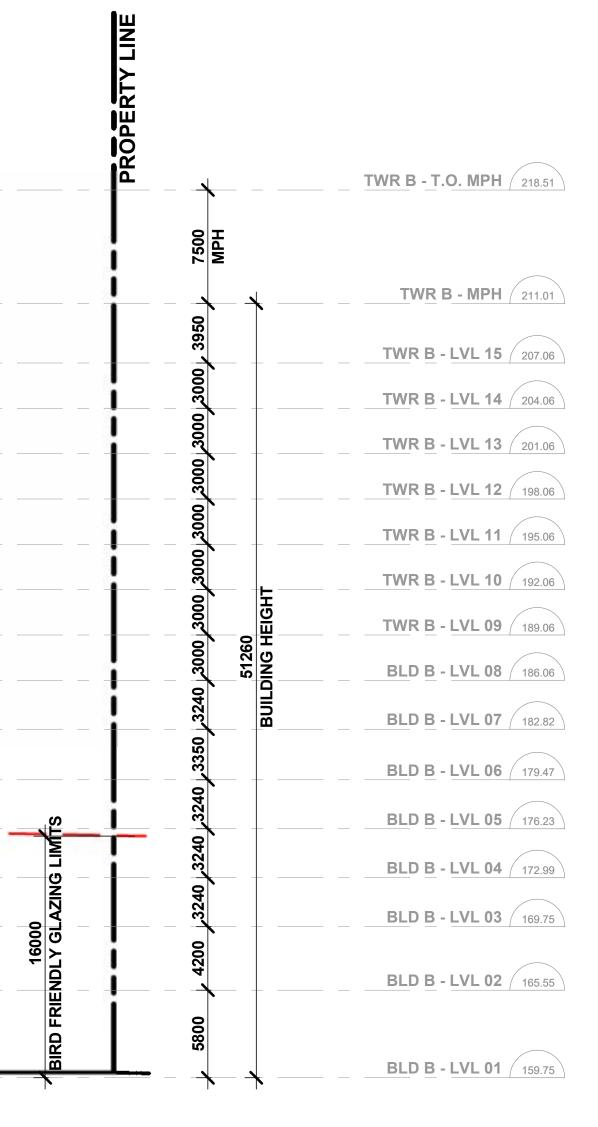

WALLMANARCHITECTS

99 Spadina Avenue, Suite 600 Toronto, Ontatrio M5V 3P8 t 416 340 1870 f 416 340 1871 www.wallmanarchitects.com



Project

1050 Markham Road

1050 Markham Road, Toronto, Ontario, M1H 2Y5

Client


CAPREIT


Drawing Title

NORTH ELEVATIONS


1 : 250	Scale
	Drawn by
	Checked by
23-11	Project No.
2024-06-07	Date
	Drawing No.

A3.01

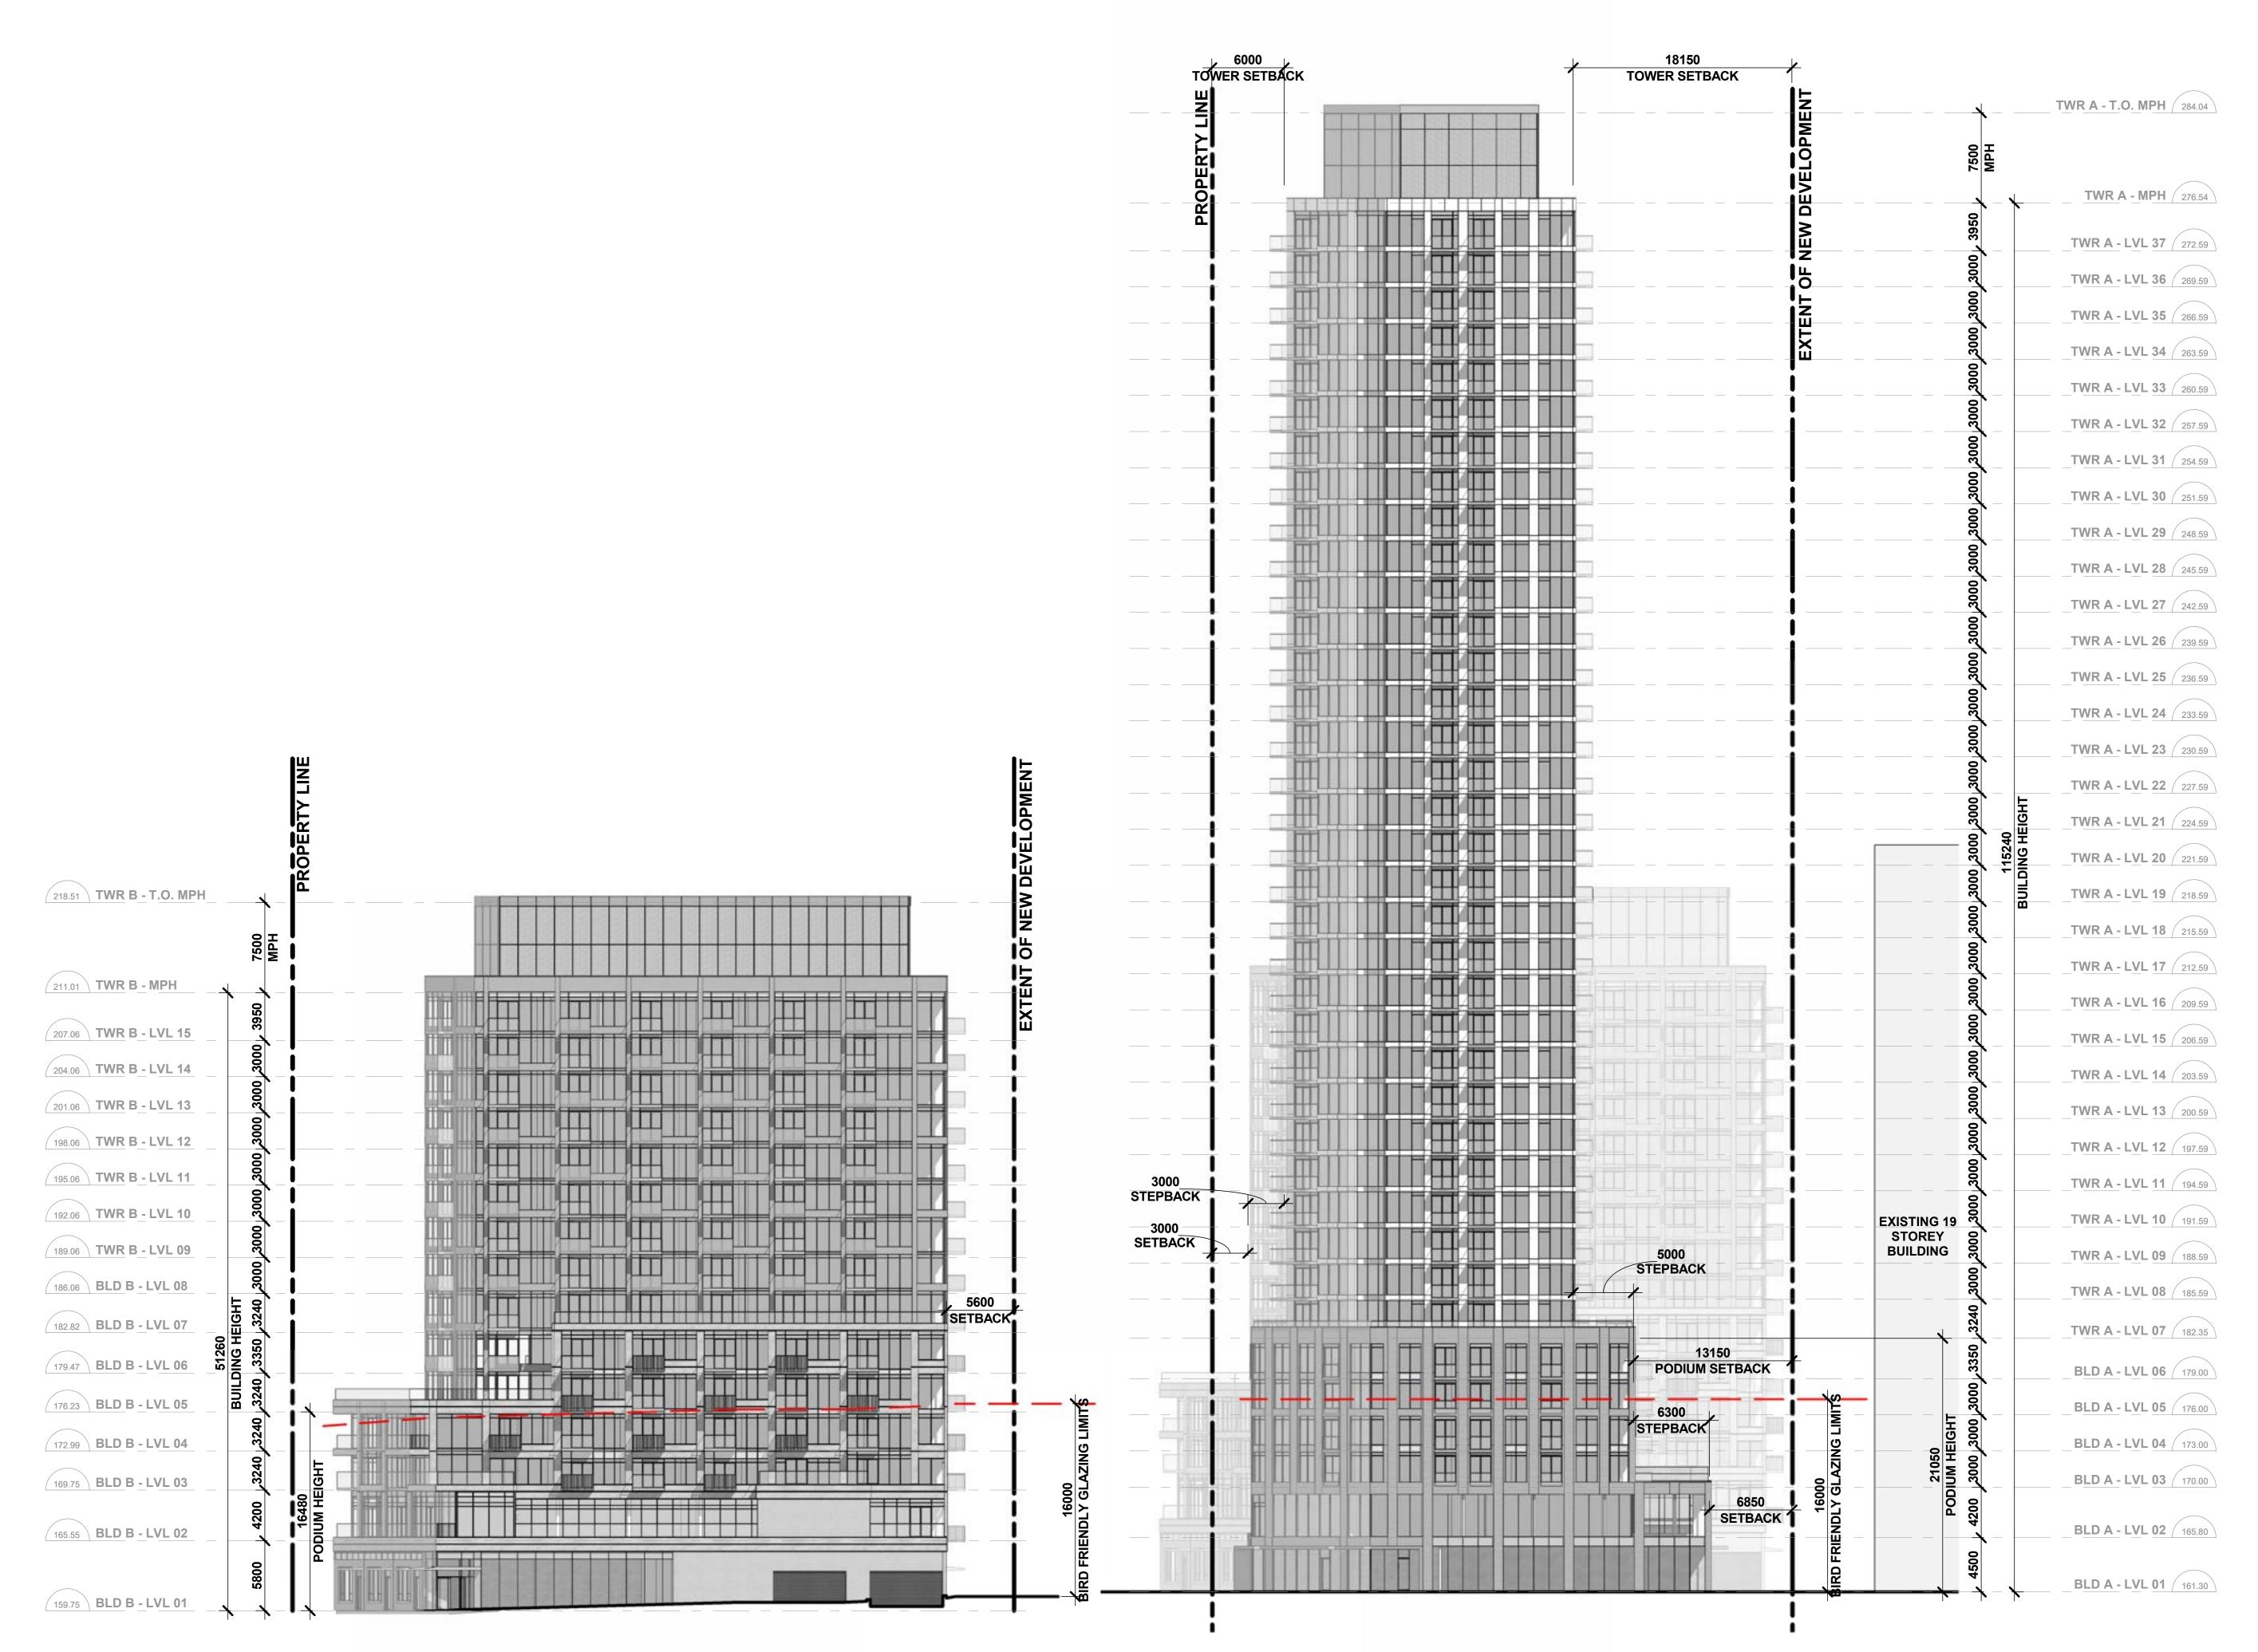

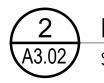



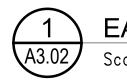

EAST ELEVATION - BUILDING A

Scale: 1 : 250

1. Copyright of this drawing is reserved by the Architect. The drawing, and all associated documents are instruments of service by the Architect. The drawing, and the information contained therein, may not be reproduced in whole or in part without prior written permission of the Architect.

2. These Contract Documents are the property of the Architect. The Architect bears no responsibility for the interpretation of these documents by the Contractor. Upon written application the Architect will provide written/graphic clarification or supplementary information regarding the intent of the Contract Documents. The Architect will review Shop Drawings submitted by the Contractor for design conformance only.

3. Drawings are not to be scaled for construction. The Contractor is to verify all existing conditions and dimensions required to perform the work and report and discrepancies with the Contract Documents to the Architect before commencing any work.

4. Positions of exposed finishes for mechanical or electrical devised, fitting and fixtures are indicated on architectural drawings. The location shown on the architectural drawing govern over the mechanical and electrical drawings. Those items not clearly located will be located as directed by the Architect.

5. These drawings are not to be used for construction unless noted below as "Issued for Construction".

6. All work is to be carried out in conformance with the Code and Bylaws of the Authorities having jurisdiction.

7. The Architect of these plans and specifications gives no warranty or representation to any party about the constructability of the building(s) represented by them. All contractors or subcontractors must satisfy themselves when bidding and at all times ensure that they can properly construct the work represented by these plans.

No	Issued For	Date
1	Issued for ZBA	2024-06-07

WALLMANARCHITECTS

99 Spadina Avenue, Suite 600 Toronto, Ontatrio M5V 3P8 t 416 340 1870 f 416 340 1871 www.wallmanarchitects.com



Project

1050 Markham Road

1050 Markham Road, Toronto, Ontario, M1H 2Y5

Client

CAPREIT


Drawing Title

Drawing No.

EAST ELEVATIONS

1 : 250	Scale
	Drawn by
	Checked by
23-11	Project No.
2024-06-07	Date

A3.02

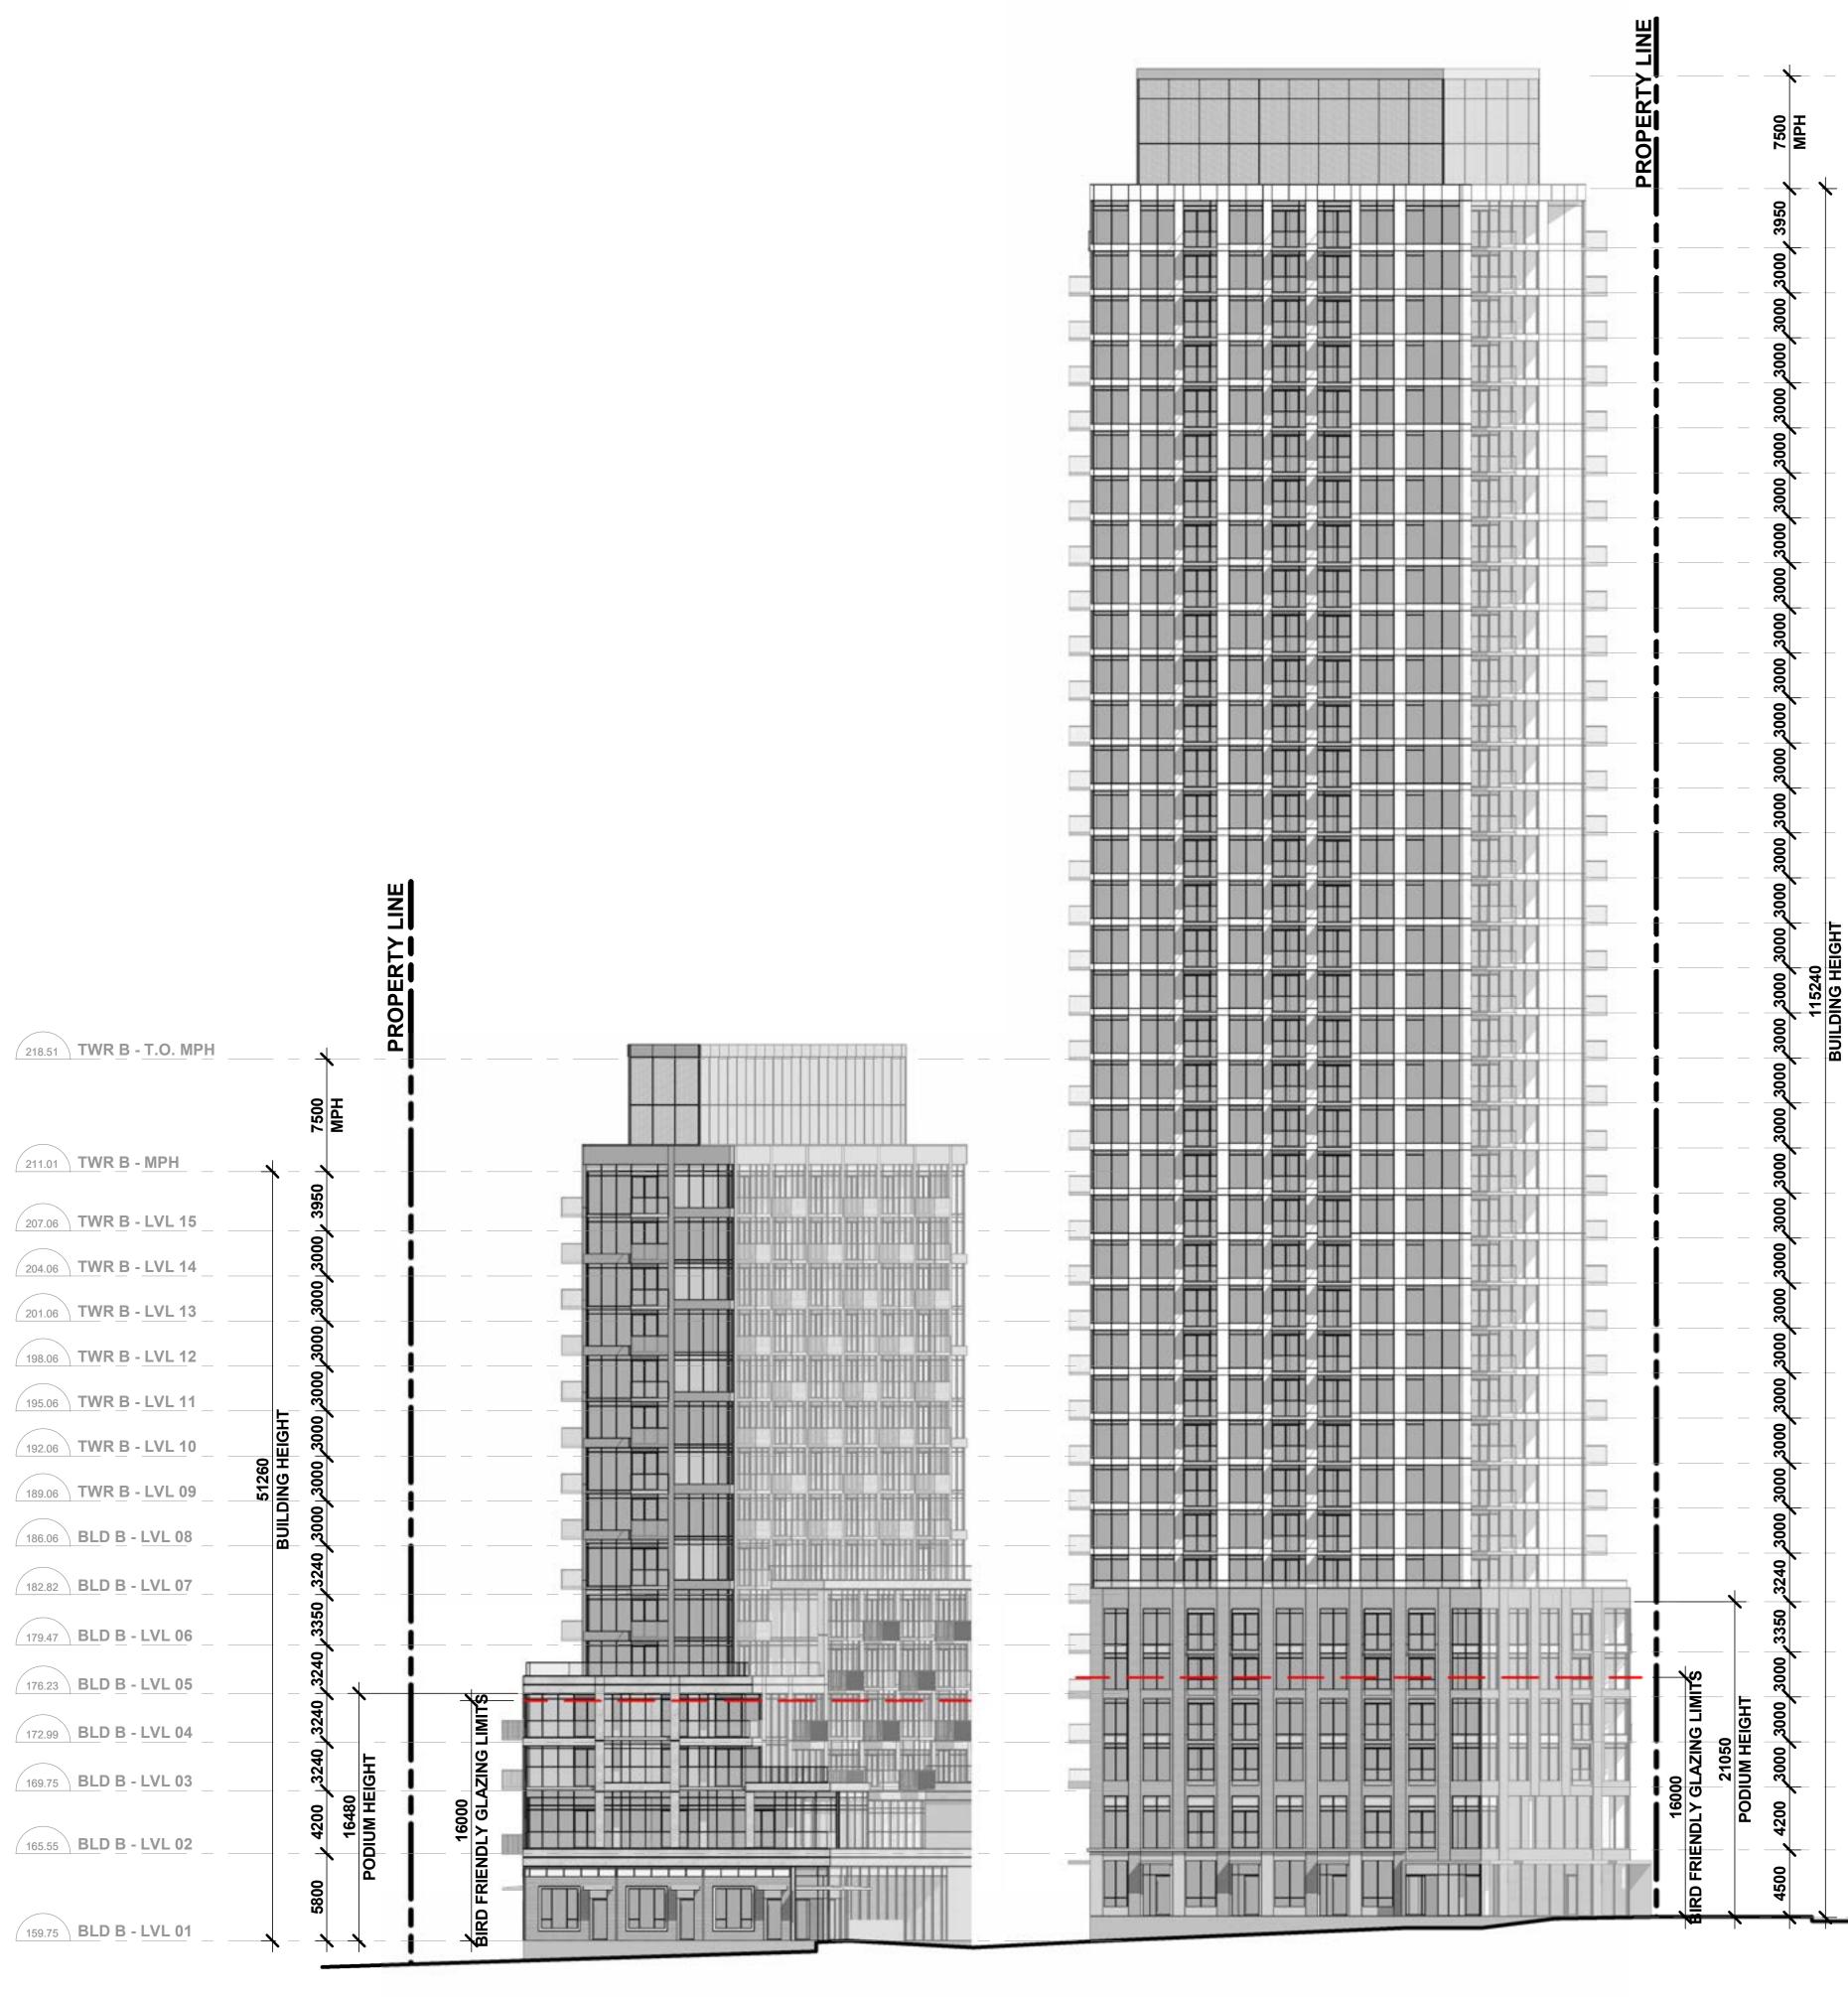







TWR A - T.O. MPH (284.04)

TWR A - MPH (276.54) TWR A - LVL 37 272.59 **TWR A - LVL 36** (269.59) **TWR A - LVL 35** (266.59) TWR A - LVL 34 263.59 TWR A - LVL 33 (260.59) TWR A - LVL 32 (257.59) **TWR A - LVL 31** (254.59) TWR A - LVL 30 251.59 **TWR A - LVL 29** (248.59) **TWR A - LVL 28** (245.59) TWR A - LVL 27 (242.59 TWR A - LVL 26 239.59 TWR A - LVL 25 236.59 TWR A - LVL 24 233.59 TWR A - LVL 23 230.59 **TWR A - LVL 22** (227.59) TWR A - LVL 21 (224.59) **TWR A - LVL 20** (221.59) **TWR A - LVL 19** (218.59) TWR A - LVL 18 (215.59) TWR A - LVL 17 212.59 TWR A - LVL 16 209.59 TWR A - LVL 15 206.59 **TWR A - LVL 14** 203.59 **TWR A - LVL 13** 200.59 TWR A - LVL 12 (197.59 TWR A - LVL 11 (194.59 0 **TWR A - LVL 10** (191.59 **TWR A - LVL 09** (188.59) TWR A - LVL 08 185.59 TWR A - LVL 07 182.35 BLD A - LVL 06 179.00 BLD A - LVL 05 176.00 BLD A - LVL 04 173.00 BLD A - LVL 03 170.00 BLD A - LVL 02 (165.80 BLD A - LVL 01 161.30 1. Copyright of this drawing is reserved by the Architect. The drawing, and all associated documents are instruments of service by the Architect. The drawing, and the information contained therein, may not be reproduced in whole or in part without prior written permission of the Architect.

2. These Contract Documents are the property of the Architect. The Architect bears no responsibility for the interpretation of these documents by the Contractor. Upon written application the Architect will provide written/graphic clarification or supplementary information regarding the intent of the Contract Documents. The Architect will review Shop Drawings submitted by the Contractor for design conformance only.

3. Drawings are not to be scaled for construction. The Contractor is to verify all existing conditions and dimensions required to perform the work and report and discrepancies with the Contract Documents to the Architect before commencing any work.

4. Positions of exposed finishes for mechanical or electrical devised, fitting and fixtures are indicated on architectural drawings. The location shown on the architectural drawing govern over the mechanical and electrical drawings. Those items not clearly located will be located as directed by the Architect.

5. These drawings are not to be used for construction unless noted below as "Issued for Construction".

6. All work is to be carried out in conformance with the Code and Bylaws of the Authorities having jurisdiction.

7. The Architect of these plans and specifications gives no warranty or representation to any party about the constructability of the building(s) represented by them. All contractors or subcontractors must satisfy themselves when bidding and at all times ensure that they can properly construct the work represented by these plans.

No Issued For Date 1 Issued for ZBA 2024-06-07

WALLMANARCHITECTS

99 Spadina Avenue, Suite 600 Toronto, Ontatrio M5V 3P8 t 416 340 1870 f 416 340 1871 www.wallmanarchitects.com



Project

1050 Markham Road

1050 Markham Road, Toronto, Ontario, M1H 2Y5

Client

CAPREIT


Drawing Title

Drawing No.

SOUTH ELEVATIONS

1 : 250	Scale
	Drawn by
	Checked by
23-11	Project No.
2024-06-07	Date

A3.03

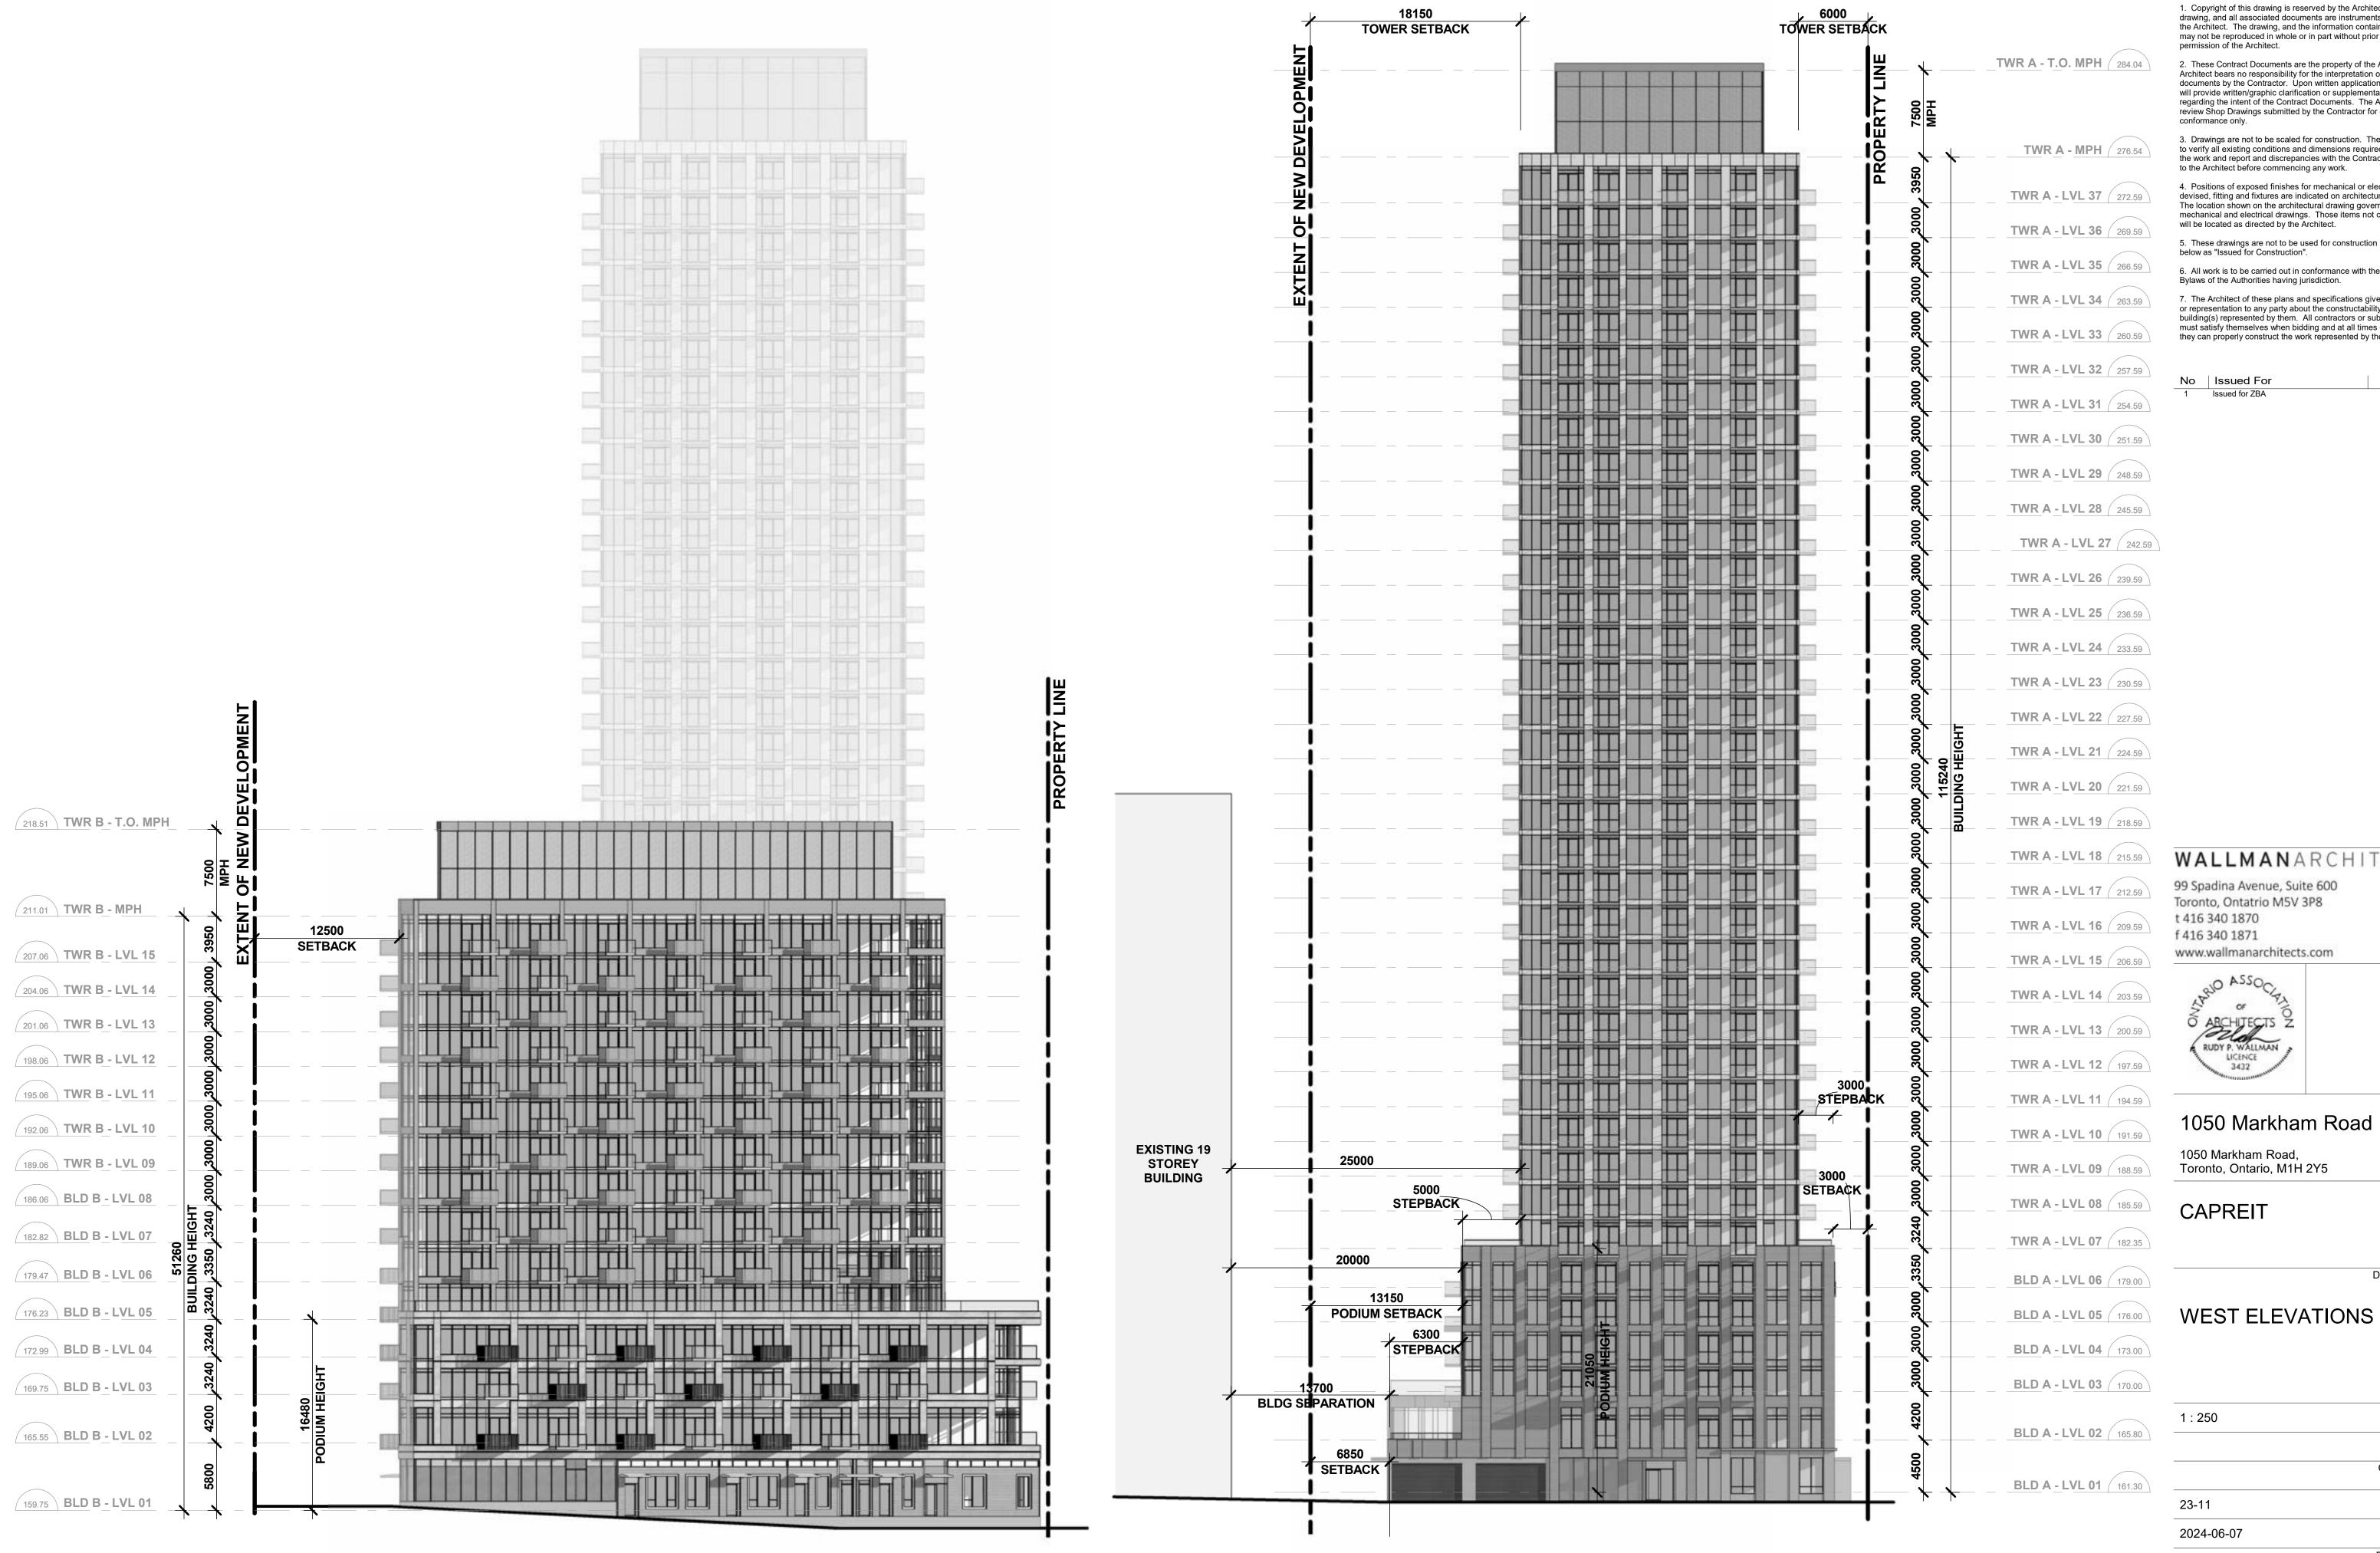

2 A3.04

WEST ELEVATION - BUILDING B

Scale: 1 : 250

1. Copyright of this drawing is reserved by the Architect. The drawing, and all associated documents are instruments of service by the Architect. The drawing, and the information contained therein, may not be reproduced in whole or in part without prior written permission of the Architect.

2. These Contract Documents are the property of the Architect. The Architect bears no responsibility for the interpretation of these documents by the Contractor. Upon written application the Architect will provide written/graphic clarification or supplementary information regarding the intent of the Contract Documents. The Architect will review Shop Drawings submitted by the Contractor for design conformance only.

3. Drawings are not to be scaled for construction. The Contractor is to verify all existing conditions and dimensions required to perform the work and report and discrepancies with the Contract Documents to the Architect before commencing any work.

4. Positions of exposed finishes for mechanical or electrical devised, fitting and fixtures are indicated on architectural drawings. The location shown on the architectural drawing govern over the mechanical and electrical drawings. Those items not clearly located will be located as directed by the Architect.

5. These drawings are not to be used for construction unless noted below as "Issued for Construction".

6. All work is to be carried out in conformance with the Code and Bylaws of the Authorities having jurisdiction.

7. The Architect of these plans and specifications gives no warranty or representation to any party about the constructability of the building(s) represented by them. All contractors or subcontractors must satisfy themselves when bidding and at all times ensure that they can properly construct the work represented by these plans.

No	Issued For	Date
1	Issued for ZBA	2024-06-07

WALLMANARCHITECTS

99 Spadina Avenue, Suite 600 Toronto, Ontatrio M5V 3P8 t 416 340 1870 f 416 340 1871 www.wallmanarchitects.com



Project

1050 Markham Road

1050 Markham Road, Toronto, Ontario, M1H 2Y5

CAPREIT

Client

Drawing Title

Drawing No

1 : 250	Scale
	Drawn by
	Checked by
23-11	Project No.
2024-06-07	Date


A3.04

WEST ELEVATION - BUILDING A

1

A3.04

Scale: 1 : 250

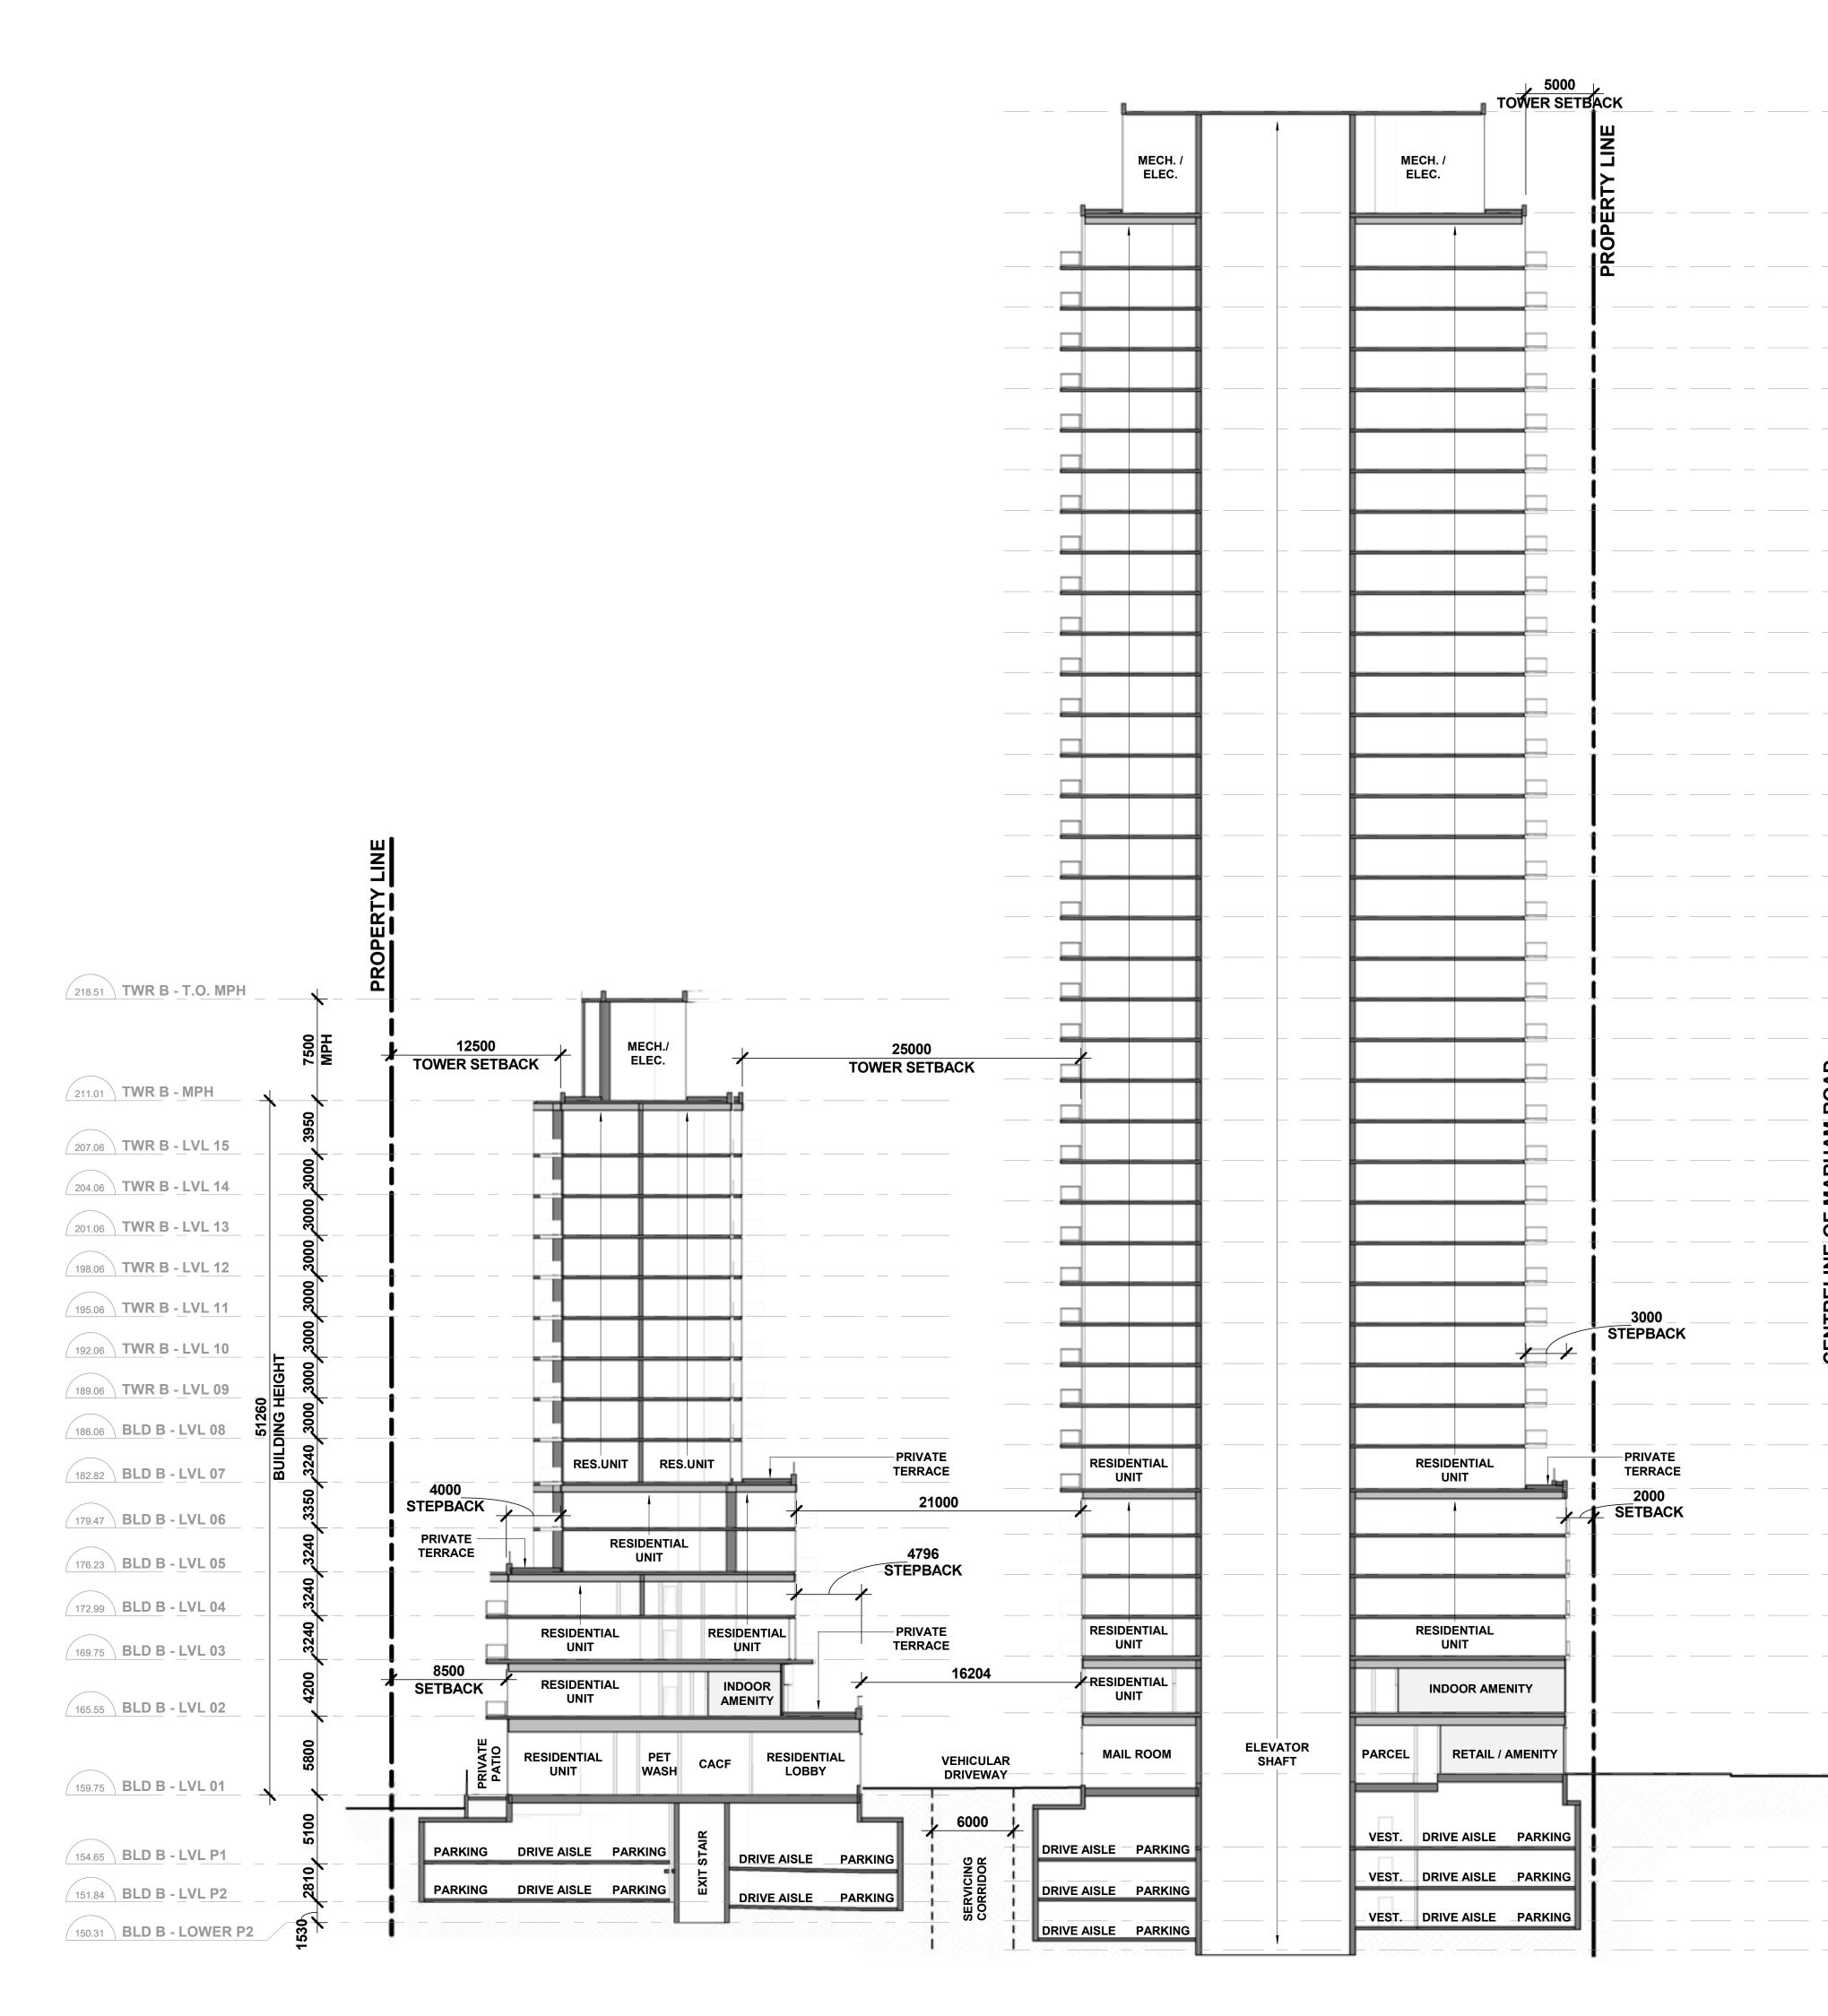

TWR A - T.O. MPH 284.04 **TWR A - MPH** (276.54) TWR A - LVL 37 (272.59 TWR A - LVL 36 269.59 TWR A - LVL 35 266.59 TWR A - LVL 34 (263.59) TWR A - LVL 33 (260.59 TWR A - LVL 32 257.59 **TWR A - LVL 31** (254.59 TWR A - LVL 30 (251.59 TWR A - LVL 29 (248.59 TWR A - LVL 28 245.59 TWR A - LVL 27 (242.59 **TWR A - LVL 26** (239.59) TWR A - LVL 25 236.59 TWR A - LVL 24 (233.59 TWR A - LVL 23 230.59 TWR A - LVL 22 (227.59) TWR A - LVL 21 (224.59 TWR A - LVL 20 (221.59 **6 표** 1152[,] **TWR A - LVL 19** (218.59) TWR A - LVL 18 215.59 TWR A - LVL 17 212.59 TWR A - LVL 16 209.59 TWR A - LVL 15 206.59 TWR A - LVL 14 203.59 TWR A - LVL 13 200.59 TWR A - LVL 12 (197.59 TWR A - LVL 11 (194.59 Ш TWR A - LVL 10 191.59 ()TWR A - LVL 09 188.59 TWR A - LVL 08 185.59 TWR A - LVL 07 (182.35 BLD A - LVL 06 179.00 BLD A - LVL 05 176.00 BLD A - LVL 04 173.00 BLD A - LVL 03 170.00 BLD A - LVL 02 165.80 BLD A - LVL 01 (161.30 BLD A - LVL P1 (155.90 BLD A - LVL P2 153.39 BLD A - LVL P3 150.44 BLD A - LOWER P3 (148.31)

2. These Contract Documents are the property of the Architect. The Architect bears no responsibility for the interpretation of these documents by the Contractor. Upon written application the Architect will provide written/graphic clarification or supplementary information regarding the intent of the Contract Documents. The Architect will review Shop Drawings submitted by the Contractor for design conformance only.

3. Drawings are not to be scaled for construction. The Contractor is to verify all existing conditions and dimensions required to perform the work and report and discrepancies with the Contract Documents to the Architect before commencing any work.

4. Positions of exposed finishes for mechanical or electrical devised, fitting and fixtures are indicated on architectural drawings. The location shown on the architectural drawing govern over the mechanical and electrical drawings. Those items not clearly located will be located as directed by the Architect.

5. These drawings are not to be used for construction unless noted below as "Issued for Construction".

6. All work is to be carried out in conformance with the Code and Bylaws of the Authorities having jurisdiction.

7. The Architect of these plans and specifications gives no warranty or representation to any party about the constructability of the building(s) represented by them. All contractors or subcontractors must satisfy themselves when bidding and at all times ensure that they can properly construct the work represented by these plans.

No	Issued For	Date
1	Issued for ZBA	2024-06-07

WALLMANARCHITECTS

99 Spadina Avenue, Suite 600 Toronto, Ontatrio M5V 3P8 t 416 340 1870 f 416 340 1871 www.wallmanarchitects.com



Project

1050 Markham Road

1050 Markham Road, Toronto, Ontario, M1H 2Y5


Client

CAPREIT

Drawing Title

BUILDING SECTION A - A

1 : 250	Scale
	Drawn by
	Checked by
23-11	Project No.
2024-06-07	Date
	Drawing No.

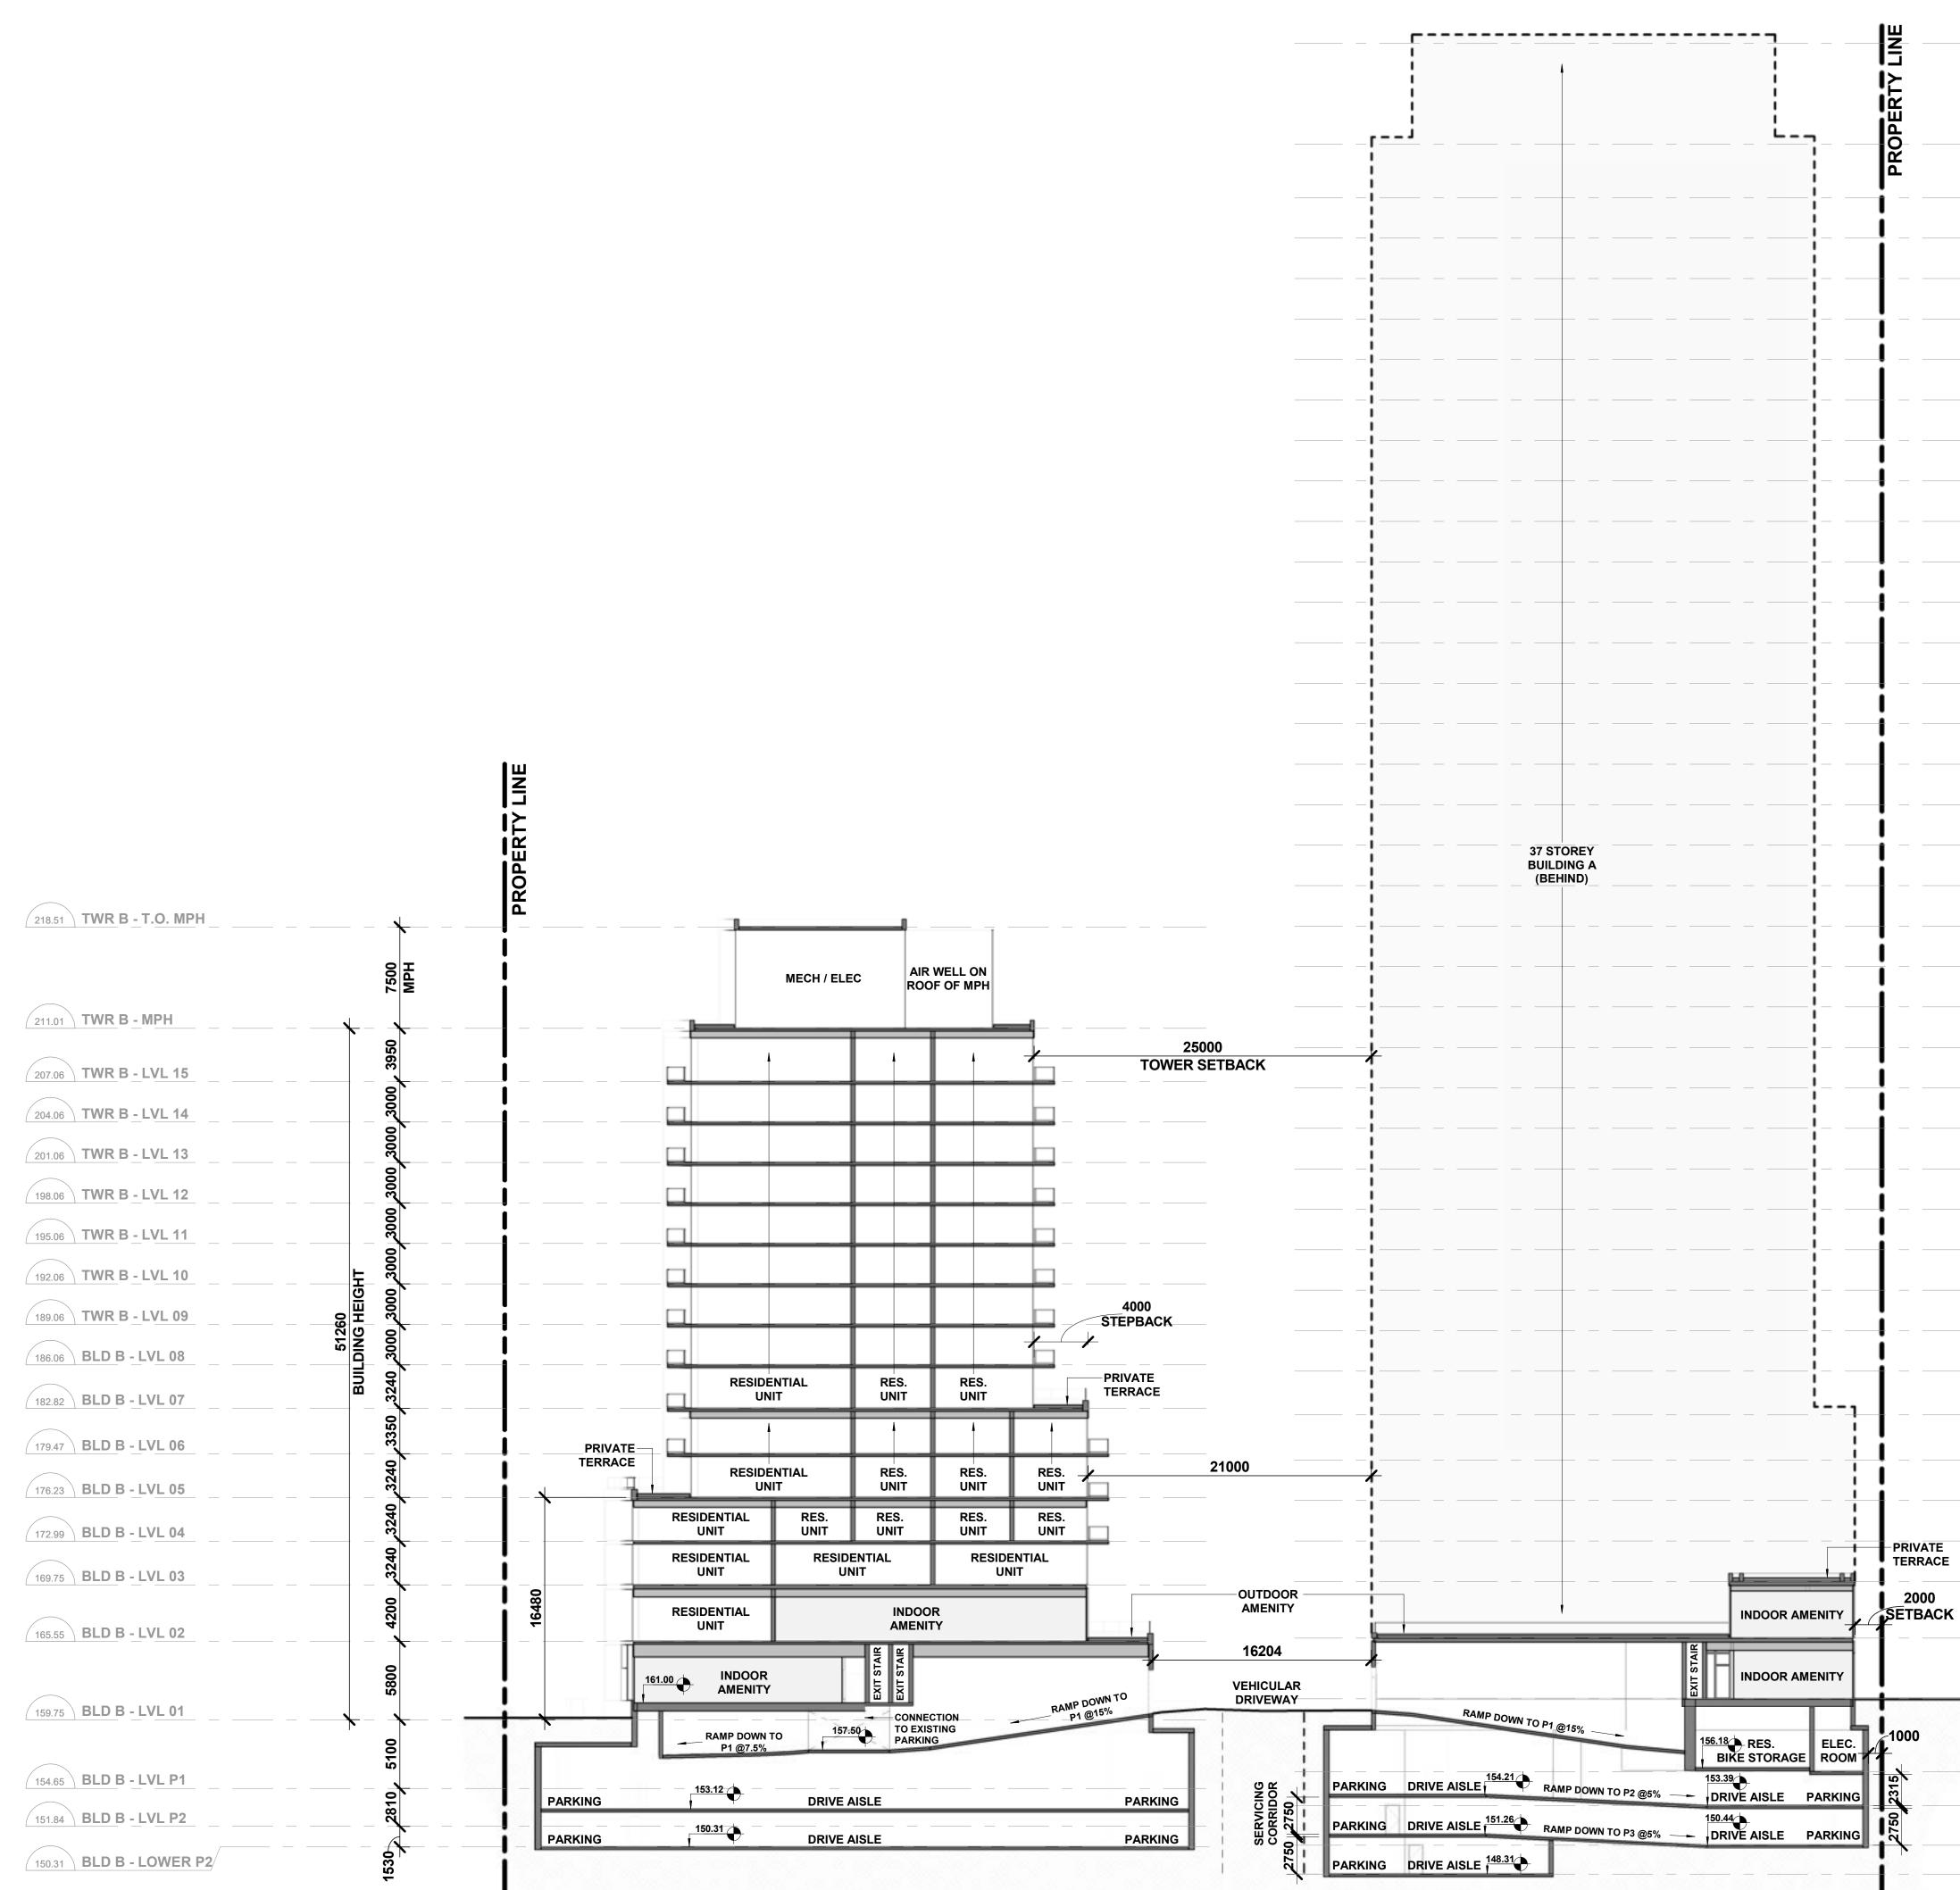

2. These Contract Documents are the property of the Architect. The Architect bears no responsibility for the interpretation of these documents by the Contractor. Upon written application the Architect will provide written/graphic clarification or supplementary information regarding the intent of the Contract Documents. The Architect will review Shop Drawings submitted by the Contractor for design conformance only.

3. Drawings are not to be scaled for construction. The Contractor is to verify all existing conditions and dimensions required to perform the work and report and discrepancies with the Contract Documents to the Architect before commencing any work.

4. Positions of exposed finishes for mechanical or electrical devised, fitting and fixtures are indicated on architectural drawings. The location shown on the architectural drawing govern over the mechanical and electrical drawings. Those items not clearly located will be located as directed by the Architect.

5. These drawings are not to be used for construction unless noted below as "Issued for Construction".

6. All work is to be carried out in conformance with the Code and Bylaws of the Authorities having jurisdiction.

7. The Architect of these plans and specifications gives no warranty or representation to any party about the constructability of the building(s) represented by them. All contractors or subcontractors must satisfy themselves when bidding and at all times ensure that they can properly construct the work represented by these plans.

No	Issued For	Date
1	Issued for ZBA	2024-06-07

WALLMANARCHITECTS

99 Spadina Avenue, Suite 600 Toronto, Ontatrio M5V 3P8 t 416 340 1870 f 416 340 1871 www.wallmanarchitects.com



Project

1050 Markham Road

1050 Markham Road, Toronto, Ontario, M1H 2Y5

Client

CAPREIT

Drawing Title

BUILDING SECTION B - B

1 : 250	Scale
	Drawn by
	Checked by
23-11	Project No.
2024-06-07	Date
	Drawing No.

		TWR A - T.O. MPH 284.04
	7500 MPH	
		TWR A - MPH 276.54
	3950	TWR A - LVL 37 272.59
	3000	TWR A - LVL 36 (269.59)
	3000	TWR A - LVL 35 266.59
	3000	TWR A - LVL 34 263.59
	3000	TWR A - LVL 33 (260.59)
	3000	
	3000	
	3000	TWR A - LVL 31 (254.59
	3000	TWR A - LVL 30 (251.59
	8	TWR A - LVL 29 (248.59
	00 30	TWR A - LVL 28 (245.59
	0002 000	TWR A - LVL 27 (242.59
	00 3000	TWR A - LVL 26 239.59
	03000	TWR A - LVL 25 236.59
	0 3000	TWR A - LVL 24 233.59
	0000	TWR A - LVL 23 230.59
	3000	TWR A - LVL 22 227.59
	3000	TWR A - LVL 21 224.59
	00 3000	TWR A - LVL 21 224.59 TWR A - LVL 20 221.59 TWR A - LVL 19 218.59
	3000	TWR A - LVL 19 218.59
	е С	TWR A - LVL 18 215.59
0	3000	TWR A - LVL 17 212.59
AM ROAD	3000	TWR A - LVL 16 209.59
	3000	TWR A - LVL 15 206.59
MARH	3000	TWR A - LVL 14 203.59
Ш Ц О	3000	TWR A - LVL 13 200.59
	3000	TWR A - LVL 12 197.59
REL	3000	TWR A - LVL 11 (194.59)
	3000	TWR A - LVL 10 (191.59)
	3000	
	3000	
	3240 3	TWR A - LVL 08 (185.59
		TWR A - LVL 07 (182.35
i i	00 3350	BLD A - LVL 06 (179.00
	0002 000	BLD A - LVL 05 176.00
	00 3000	BLD A - LVL 04 173.00
	3000	BLD A - LVL 03 170.00
	, 4200	BLD A - LVL 02 (165.80)
	4500	
	- → →	BLD A - LVL 01 161.30
	5400	
	2515	BLD A - LVL P1 155.90
	350 25	BLD A - LVL P2 (153.39
	2130,2950	BLD A - LVL P3 (150.44) BLD A - LOWER P3 (148.31)

		L	TOWER S	000 SETBACK	TWR
		MECH./ ELEC.	MECH./ ELEC.		7500 MPH
				ROPERT	_ _ _ _
		+	· · · · · · · · · · · · · · · · · · ·	PRO	3320
				— i – — – – – –	
					0000 TWI
					0000 TWI
25000					
TOWER SEPAR	ATION				
<					
AREA					IML 0 3000 300 IML 120640 IML 120640
M 0					TWI
					0000 TW
					3000 TW
ЦО Ц					
					TW
					000 TW
					0000 TW
	5000 STEPBACK			•	000 TW
i					TW
· -	PRIVATE RESI	DENTIAL JNIT		PRIVATE	540
i					320
· -¦			~		
		STAIR	ELEVATOR SHAFT		BL 0000000000000000000000000000000
13700	RESIDENTIAL				0008 BL
8310					
SETBACK	AMENITY 166.03 AMENIT	R Y	RESIDENTIAL UNIT		BLI
OUTDOOR	GARBA	ЭF		SE/ METAL FENCE	4200
AMENITY	RAMP			교 전/ (SEE LANDSCAPE)	
	TO P1	XIT MECH/	RAMP 155.31 ELEV. DN TO LOWER MECH		5400
PARKING R		TAIR ELEC. XIT MECH/	ELEV. RAMP		BLI
		TAIR ELEC.	LOBBY DN TO LOWER P2 @5% PARKII ELEV. RAMP	NG	,
		TAIR ELEC.	LOBBY DN TO LOWER P3 @5% PARKII		XBLI

BUILDI

EXISTIN

T.O. MPH 284.04

R A - MPH 276.54 A - LVL 37 272.59 **- LVL 36** (269.59 - LVL 35 (266.59 **- LVL 34** (263.59) **- LVL 33** (260.59) - LVL 32 257.59 **- LVL 31** (254.59) **- LVL 30** (251.59) - LVL 29 (248.59 **- LVL 28** (245.59) - LVL 27 (242.59 **A - LVL 26** (239.59) **- LVL 25** (236.59) **- LVL 24** (233.59) - LVL 23 (230.59 **- LVL 22** (227.59) **- LVL 21** (224.59) A - LVL 20 (221.59) **- LVL 19** (218.59) **- LVL 18** 215.59 - LVL 17 212.59 - LVL 16 209.59 - LVL 15 206.59 - LVL 14 203.59 - LVL 13 200.59 - LVL 12 197.59 - LVL 11 194.59 - LVL 10 191.59 - LVL 09 188.59 - LVL 08 185.59 - LVL 07 182.35 - LVL 06 179.00 - LVL 05 176.00 - LVL 04 173.00 - LVL 03 170.00 - LVL 02 165.80 - LVL 01 161.30

- LVL P1 155.90 - LVL P2 153.39 - LVL P3 150.44 OWER P3 148.31

1. Copyright of this drawing is reserved by the Architect. The drawing, and all associated documents are instruments of service by the Architect. The drawing, and the information contained therein, may not be reproduced in whole or in part without prior written permission of the Architect.

2. These Contract Documents are the property of the Architect. The Architect bears no responsibility for the interpretation of these documents by the Contractor. Upon written application the Architect will provide written/graphic clarification or supplementary information regarding the intent of the Contract Documents. The Architect will review Shop Drawings submitted by the Contractor for design conformance only.

3. Drawings are not to be scaled for construction. The Contractor is to verify all existing conditions and dimensions required to perform the work and report and discrepancies with the Contract Documents to the Architect before commencing any work.

4. Positions of exposed finishes for mechanical or electrical devised, fitting and fixtures are indicated on architectural drawings. The location shown on the architectural drawing govern over the mechanical and electrical drawings. Those items not clearly located will be located as directed by the Architect.

5. These drawings are not to be used for construction unless noted below as "Issued for Construction".

6. All work is to be carried out in conformance with the Code and Bylaws of the Authorities having jurisdiction.

7. The Architect of these plans and specifications gives no warranty or representation to any party about the constructability of the building(s) represented by them. All contractors or subcontractors must satisfy themselves when bidding and at all times ensure that they can properly construct the work represented by these plans.

Date No Issued For 1 Issued for ZBA 2024-06-07

WALLMANARCHITECTS

99 Spadina Avenue, Suite 600 Toronto, Ontatrio M5V 3P8 t 416 340 1870 f 416 340 1871 www.wallmanarchitects.com



Project

1050 Markham Road

1050 Markham Road, Toronto, Ontario, M1H 2Y5

Client

CAPREIT

Drawing Title

BUILDING SECTION C - C

1 : 250	Scale
	Drawn by
	Checked by
23-11	Project No.
2024-06-07	Date
	Drawing No.



													PROPE	
][-	
][
				;										
][
][_	
]								 -	
					1 Г									
				· · · ·	<u> </u>									
											RIVATE ERRACE			
		_										ļ		
													İ	
DENTIAL UNIT	RESIDENT UNIT	IAL F	RESIDENTIAL UNIT	RESIDENTIAL UNIT	RESIDEN			DENTIAL UNIT		RESIDENTIAL UNIT				
ITY		ι	DENTIAL JNIT	RESIDENTIAL UNIT	RES. UNIT	EXIT STAIR	EXIT STAIR	RES. UNIT	CORRIDOR	RESIDENTIA UNIT		PRIVATE PATIO	PEDESTRIAN	SIDEWALN
														3
	@15%	-		RA	MP DN TO P1	@ 5%			1	154.65	SER	CH. / VICE / ROOMS	3100	
IVE AISLE				RA	MP DN TO P2	@ 5%			4	151.84			2610	
IVE AISLE														
													0. 1 0.72	

1. Copyright of this drawing is reserved by the Architect. The drawing, and all associated documents are instruments of service by the Architect. The drawing, and the information contained therein, may not be reproduced in whole or in part without prior written permission of the Architect.

2. These Contract Documents are the property of the Architect. The Architect bears no responsibility for the interpretation of these documents by the Contractor. Upon written application the Architect will provide written/graphic clarification or supplementary information regarding the intent of the Contract Documents. The Architect will review Shop Drawings submitted by the Contractor for design conformance only. conformance only.

3. Drawings are not to be scaled for construction. The Contractor is to verify all existing conditions and dimensions required to perform the work and report and discrepancies with the Contract Documents to the Architect before commencing any work.

4. Positions of exposed finishes for mechanical or electrical devised, fitting and fixtures are indicated on architectural drawings. The location shown on the architectural drawing govern over the mechanical and electrical drawings. Those items not clearly located will be located as directed by the Architect.

5. These drawings are not to be used for construction unless noted below as "Issued for Construction".

All work is to be carried out in conformance with the Code and Bylaws of the Authorities having jurisdiction.

7. The Architect of these plans and specifications gives no warranty or representation to any party about the constructability of the building(s) represented by them. All contractors or subcontractors must satisfy themselves when bidding and at all times ensure that they can properly construct the work represented by these plans.

Date No Issued For 1 Issued for ZBA 2024-06-07

WALLMANARCHITECTS

99 Spadina Avenue, Suite 600 Toronto, Ontatrio M5V 3P8 t 416 340 1870 f 416 340 1871 www.wallmanarchitects.com



Project

1050 Markham Road

1050 Markham Road, Toronto, Ontario, M1H 2Y5

Client

CAPREIT


Drawing Title

BUILDING SECTION D - D

1 : 150	Scale
	Drawn by
	Checked by
23-11	Project No.
2024-06-07	Date
	Drawing No.

A4.04

DRIV 0

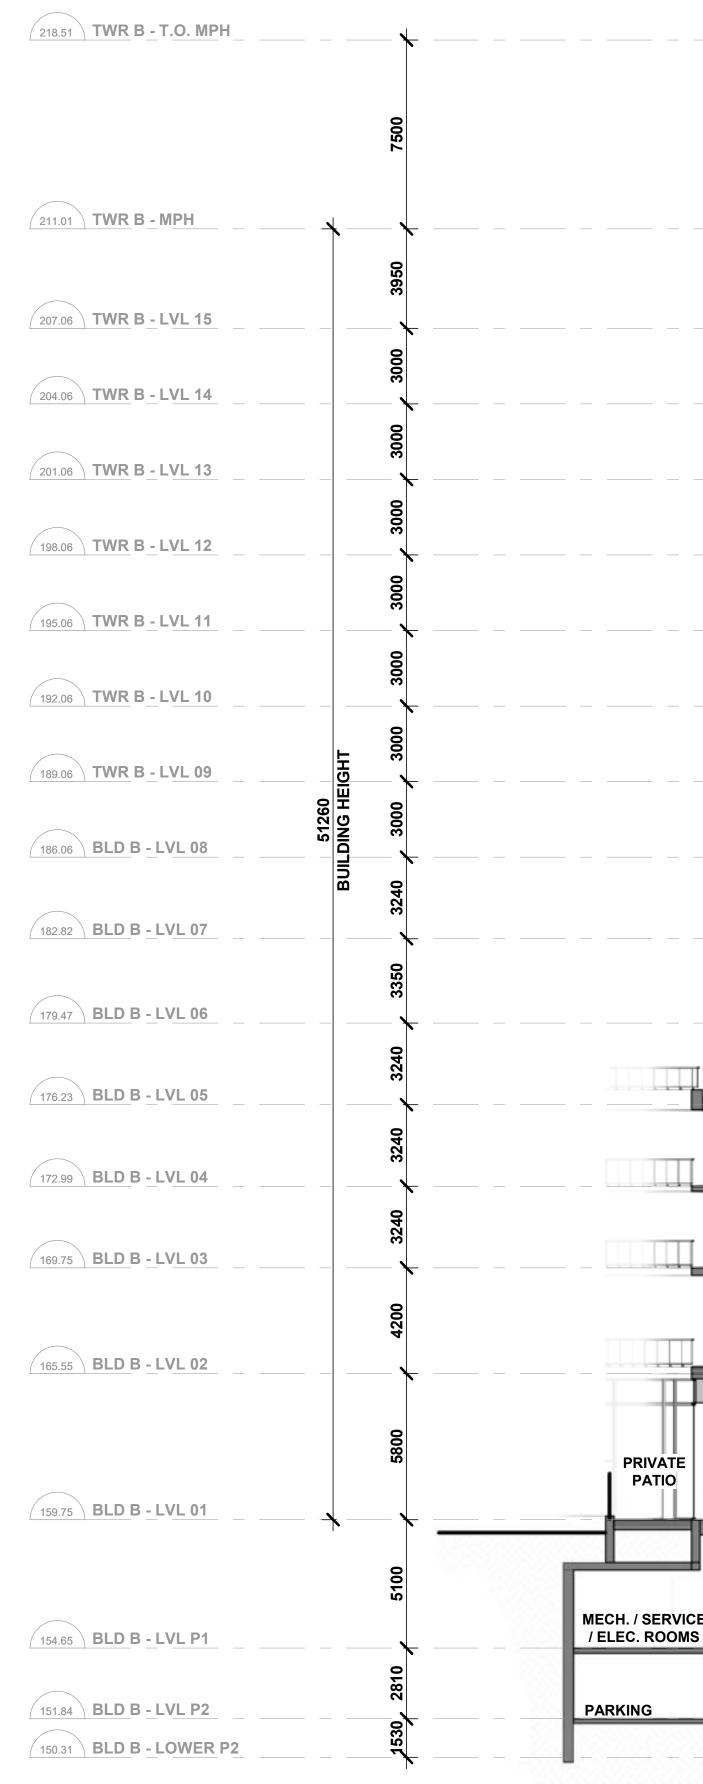

				PRIVATE TERRACES	5		
	PRIVATE TERRACE						
RESIDENTIA	LUNIT	RESIDENTIAL UNIT	RESIDENTIAL UNIT	RESIDENTIAL UNIT	RESIDENTIAL UNIT	RESIDENTIAL UNIT	
RESIDENTIA		INDOOR AN	IENITY			INDOOR AMENITY	
	JNIT	RESIDENTIAL LOB	GA	ESIDENTIAL ARBAGE BIN STORAGE STING BUILDING)	LOADING	PARKING RAMP	0

2. These Contract Documents are the property of the Architect. The Architect bears no responsibility for the interpretation of these documents by the Contractor. Upon written application the Architect will provide written/graphic clarification or supplementary information regarding the intent of the Contract Documents. The Architect will review Shop Drawings submitted by the Contractor for design conformance only.

3. Drawings are not to be scaled for construction. The Contractor is to verify all existing conditions and dimensions required to perform the work and report and discrepancies with the Contract Documents to the Architect before commencing any work.

4. Positions of exposed finishes for mechanical or electrical devised, fitting and fixtures are indicated on architectural drawings. The location shown on the architectural drawing govern over the mechanical and electrical drawings. Those items not clearly located will be located as directed by the Architect.

5. These drawings are not to be used for construction unless noted below as "Issued for Construction".

All work is to be carried out in conformance with the Code and Bylaws of the Authorities having jurisdiction.

7. The Architect of these plans and specifications gives no warranty or representation to any party about the constructability of the building(s) represented by them. All contractors or subcontractors must satisfy themselves when bidding and at all times ensure that they can properly construct the work represented by these plans.

 No
 Issued For
 Date

 1
 Issued for ZBA
 2024-06-07

WALLMANARCHITECTS

99 Spadina Avenue, Suite 600 Toronto, Ontatrio M5V 3P8 t 416 340 1870 f 416 340 1871 www.wallmanarchitects.com



Project

1050 Markham Road

1050 Markham Road, Toronto, Ontario, M1H 2Y5

Client


CAPREIT

Drawing Title

BUILDING SECTION E - E

1 : 150	Scale
	Drawn by
	Checked by
23-11	Project No.
2024-06-07	Date
	Drawing No.



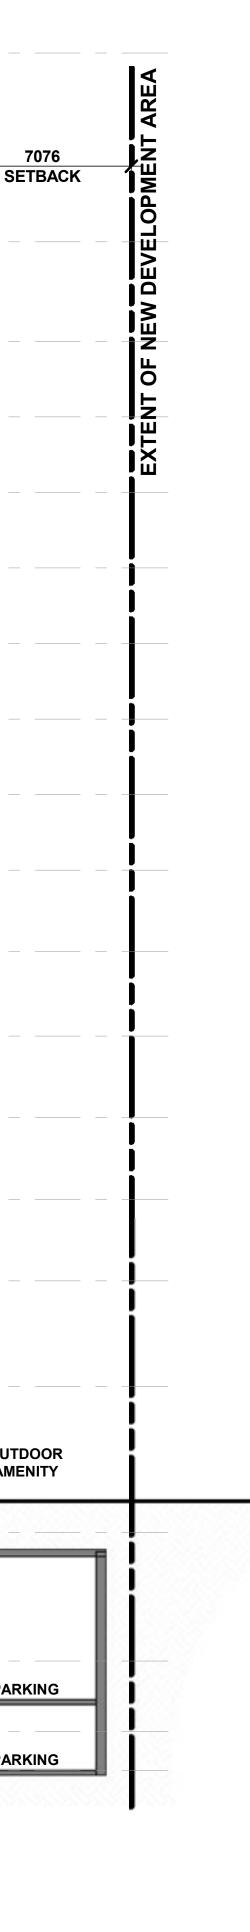



2. These Contract Documents are the property of the Architect. The Architect bears no responsibility for the interpretation of these documents by the Contractor. Upon written application the Architect will provide written/graphic clarification or supplementary information regarding the intent of the Contract Documents. The Architect will review Shop Drawings submitted by the Contractor for design conformance only.

3. Drawings are not to be scaled for construction. The Contractor is to verify all existing conditions and dimensions required to perform the work and report and discrepancies with the Contract Documents to the Architect before commencing any work.

4. Positions of exposed finishes for mechanical or electrical devised, fitting and fixtures are indicated on architectural drawings. The location shown on the architectural drawing govern over the mechanical and electrical drawings. Those items not clearly located will be located as directed by the Architect.

5. These drawings are not to be used for construction unless noted below as "Issued for Construction".

6. All work is to be carried out in conformance with the Code and Bylaws of the Authorities having jurisdiction.

7. The Architect of these plans and specifications gives no warranty or representation to any party about the constructability of the building(s) represented by them. All contractors or subcontractors must satisfy themselves when bidding and at all times ensure that they can properly construct the work represented by these plans.

No	Issued For	Date
1	Issued for ZBA	2024-06-07

WALLMANARCHITECTS

99 Spadina Avenue, Suite 600 Toronto, Ontatrio M5V 3P8 t 416 340 1870 f 416 340 1871 www.wallmanarchitects.com



Project

1050 Markham Road

1050 Markham Road, Toronto, Ontario, M1H 2Y5

Client

CAPREIT

Drawing Title

Drawing No.

WALL SECTIONS -BUILDING B

1 : 150	Scale
	Drawn by
	Checked by
23-11	Project No.
2024-06-07	Date



VIEW FROM BRIMORTON DRIVE - LOOKING NORTH-EAST 2



AERIAL VIEW FROM BRIMORTON DRIVE - LOOKING NORTH-EAST 1

1. Copyright of this drawing is reserved by the Architect. The drawing, and all associated documents are instruments of service by the Architect. The drawing, and the information contained therein, may not be reproduced in whole or in part without prior written permission of the Architect.

2. These Contract Documents are the property of the Architect. The Architect bears no responsibility for the interpretation of these documents by the Contractor. Upon written application the Architect will provide written/graphic clarification or supplementary information regarding the intent of the Contract Documents. The Architect will review Shop Drawings submitted by the Contractor for design conformance only. conformance only.

Drawings are not to be scaled for construction. The Contractor is to verify all existing conditions and dimensions required to perform the work and report and discrepancies with the Contract Documents to the Architect before commencing any work.

 Positions of exposed finishes for mechanical or electrical devised, fitting and fixtures are indicated on architectural drawings. The location shown on the architectural drawing govern over the mechanical and electrical drawings. Those items not clearly located will be located as directed by the Architect.

5. These drawings are not to be used for construction unless noted below as "Issued for Construction".

All work is to be carried out in conformance with the Code and Bylaws of the Authorities having jurisdiction.

7. The Architect of these plans and specifications gives no warranty or representation to any party about the constructability of the building(s) represented by them. All contractors or subcontractors must satisfy themselves when bidding and at all times ensure that they can properly construct the work represented by these plans.

No	Issued For	Date
1	Issued for ZBA	2024-06-07

WALLMANARCHITECTS

99 Spadina Avenue, Suite 600 Toronto, Ontatrio M5V 3P8 t 416 340 1870 f 416 340 1871 www.wallmanarchitects.com



Project

1050 Markham Road

1050 Markham Road, Toronto, Ontario, M1H 2Y5

Client

CAPREIT


Drawing Title

Drawing No.

PERSPECTIVES


	Scale
	Drawn by
	Checked by
23-11	Project No.
2024-06-07	Date


A5.02

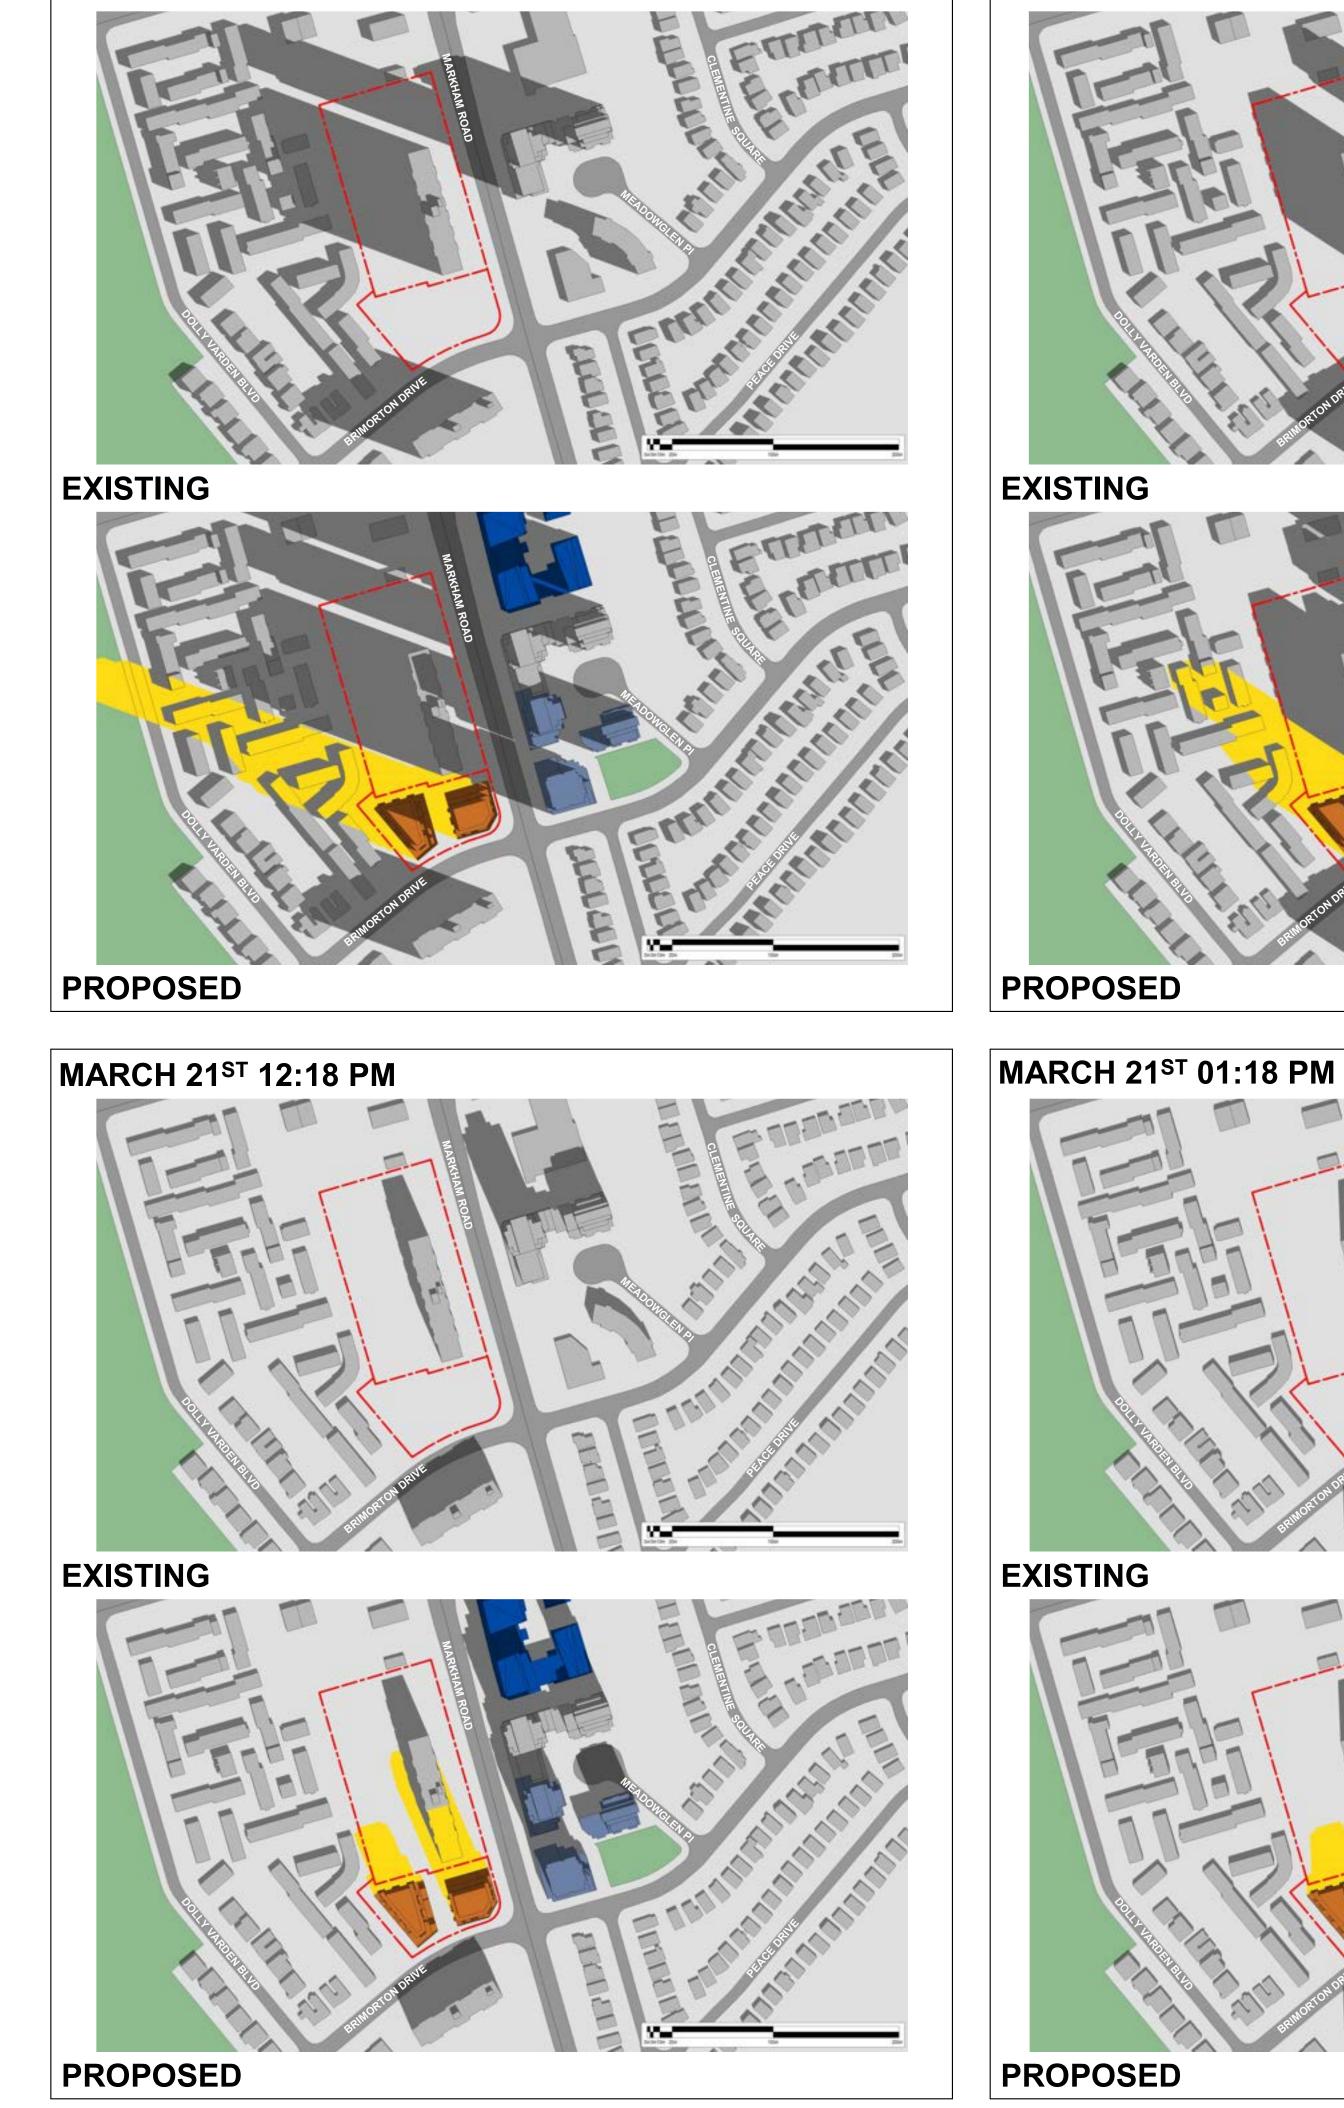

MARCH 21ST 9:18 AM

PROPOSED

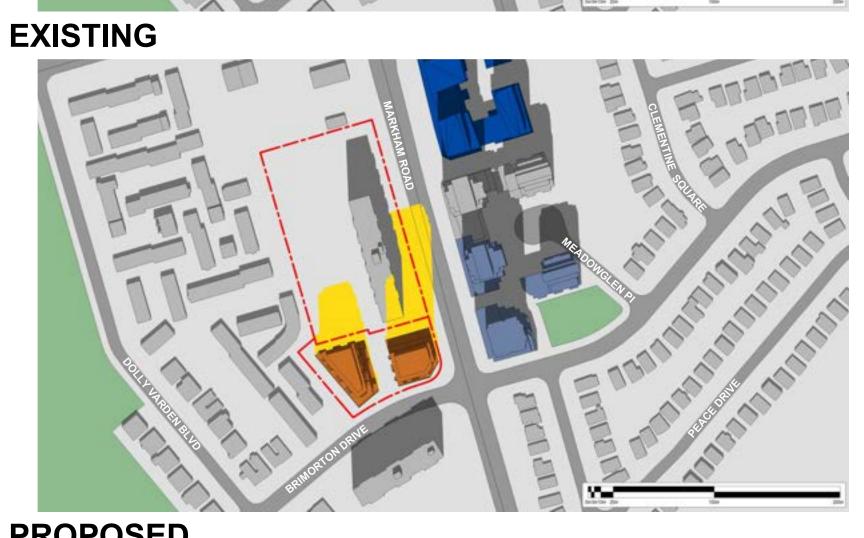

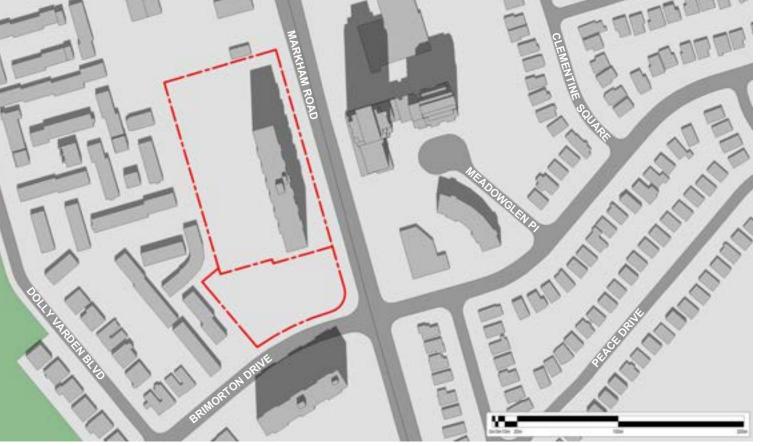


PROPOSED







PROPOSED

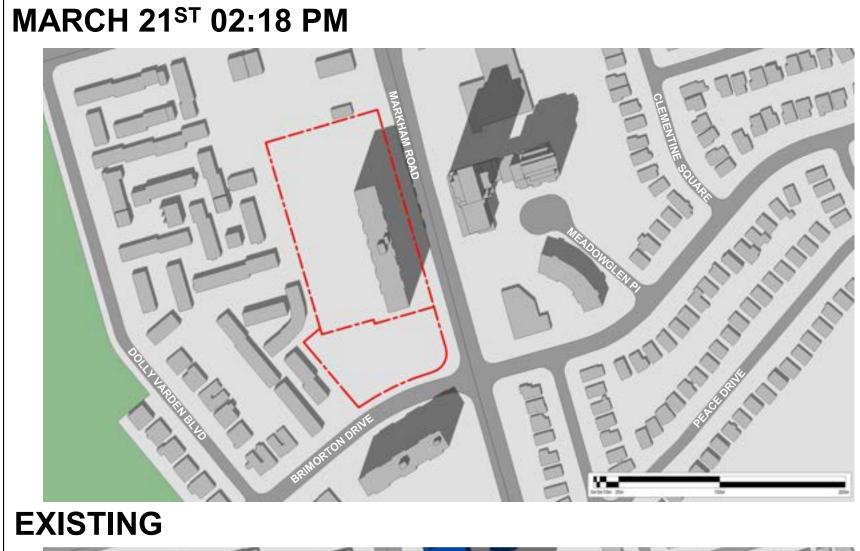

PROPOSED

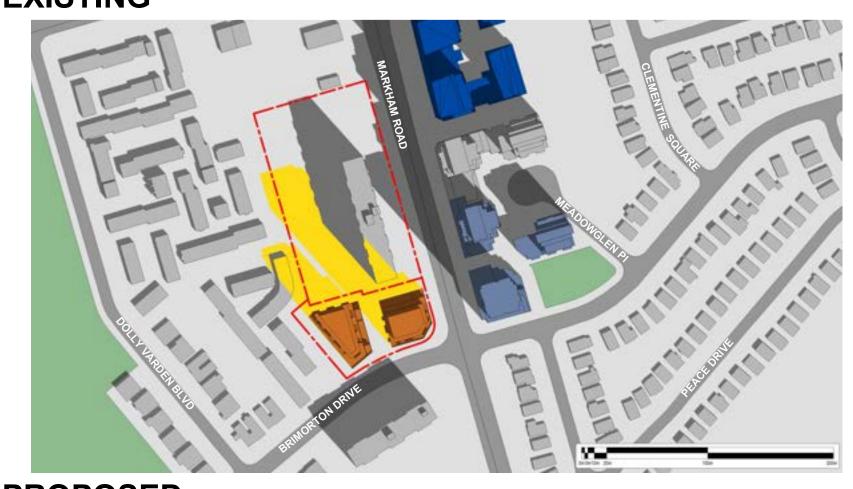

EXISTING

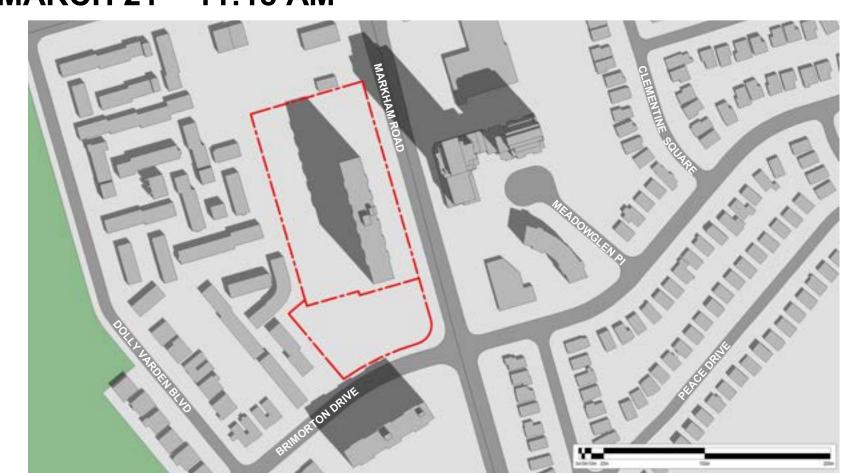

MARCH 21ST 10:18 AM

MARCH 21ST 11:18 AM



1. Copyright of this drawing is reserved by the Architect. The drawing, and all associated documents are instruments of service by the Architect. The drawing, and the information contained therein, may not be reproduced in whole or in part without prior written permission of the Architect.

2. These Contract Documents are the property of the Architect. The Architect bears no responsibility for the interpretation of these documents by the Contractor. Upon written application the Architect will provide written/graphic clarification or supplementary information regarding the intent of the Contract Documents. The Architect will review Shop Drawings submitted by the Contractor for design conformance only.

3. Drawings are not to be scaled for construction. The Contractor is to verify all existing conditions and dimensions required to perform the work and report and discrepancies with the Contract Documents to the Architect before commencing any work.

4. Positions of exposed finishes for mechanical or electrical devised, fitting and fixtures are indicated on architectural drawings. The location shown on the architectural drawing govern over the mechanical and electrical drawings. Those items not clearly located will be located as directed by the Architect.

5. These drawings are not to be used for construction unless noted below as "Issued for Construction".

6. All work is to be carried out in conformance with the Code and Bylaws of the Authorities having jurisdiction.

7. The Architect of these plans and specifications gives no warranty or representation to any party about the constructability of the building(s) represented by them. All contractors or subcontractors must satisfy themselves when bidding and at all times ensure that they can properly construct the work represented by these plans.


No	Issued For	Date
1	Issued for ZBA	2024-06-07

LEGEND



WALLMANARCHITECTS

99 Spadina Avenue, Suite 600 Toronto, Ontatrio M5V 3P8 t 416 340 1870 f 416 340 1871 www.wallmanarchitects.com

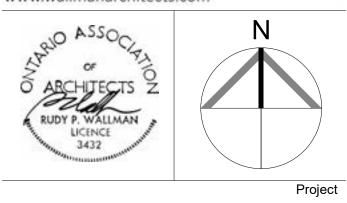

1050 Markham Road

1050 Markham Road, Toronto, Ontario, M1H 2Y5

CAPREIT

Client


Drawing Title


Drawing No.

SHADOW STUDIES MARCH

1 : 3000	Scale
	Drawn by
	Checked by
23-11	Project No.
2024-06-07	Date


A6.01

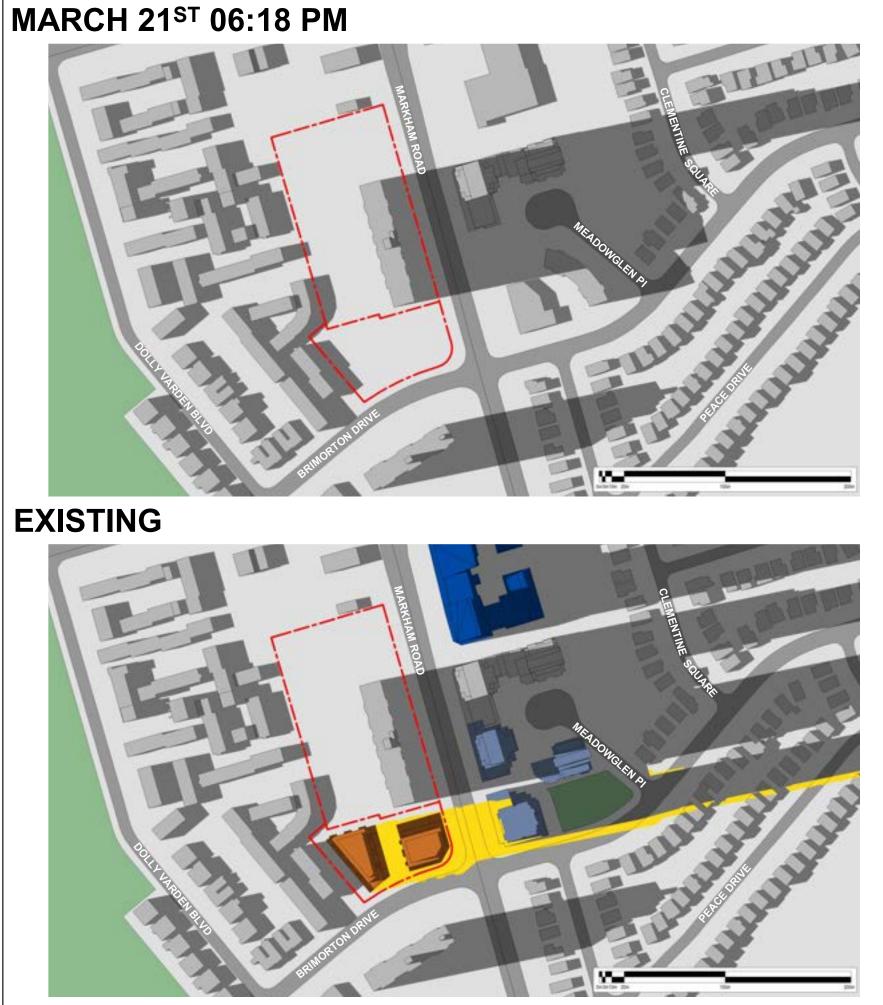

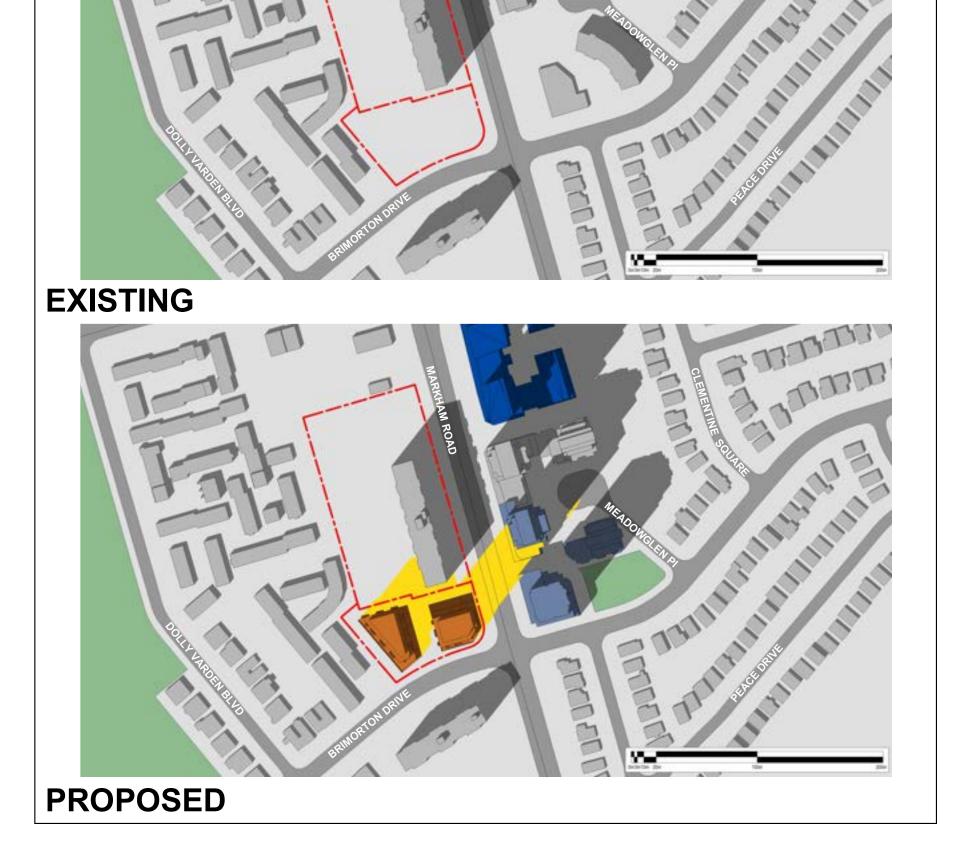


MARCH 21ST 03:18 PM



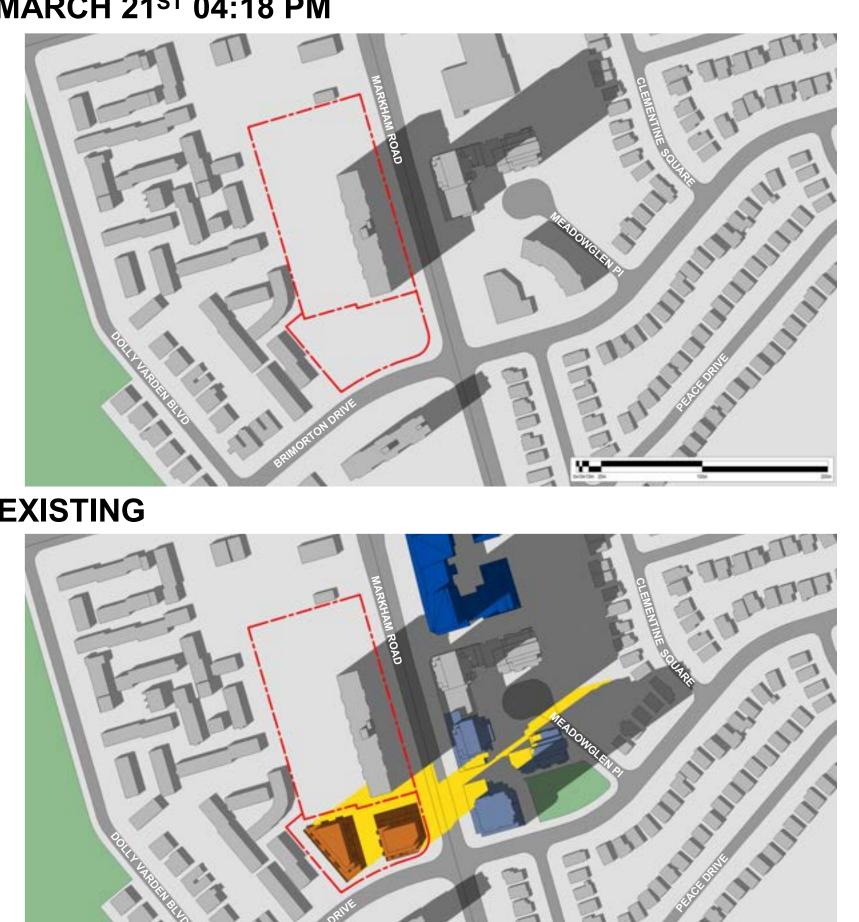

MARCH 21ST 04:18 PM

PROPOSED

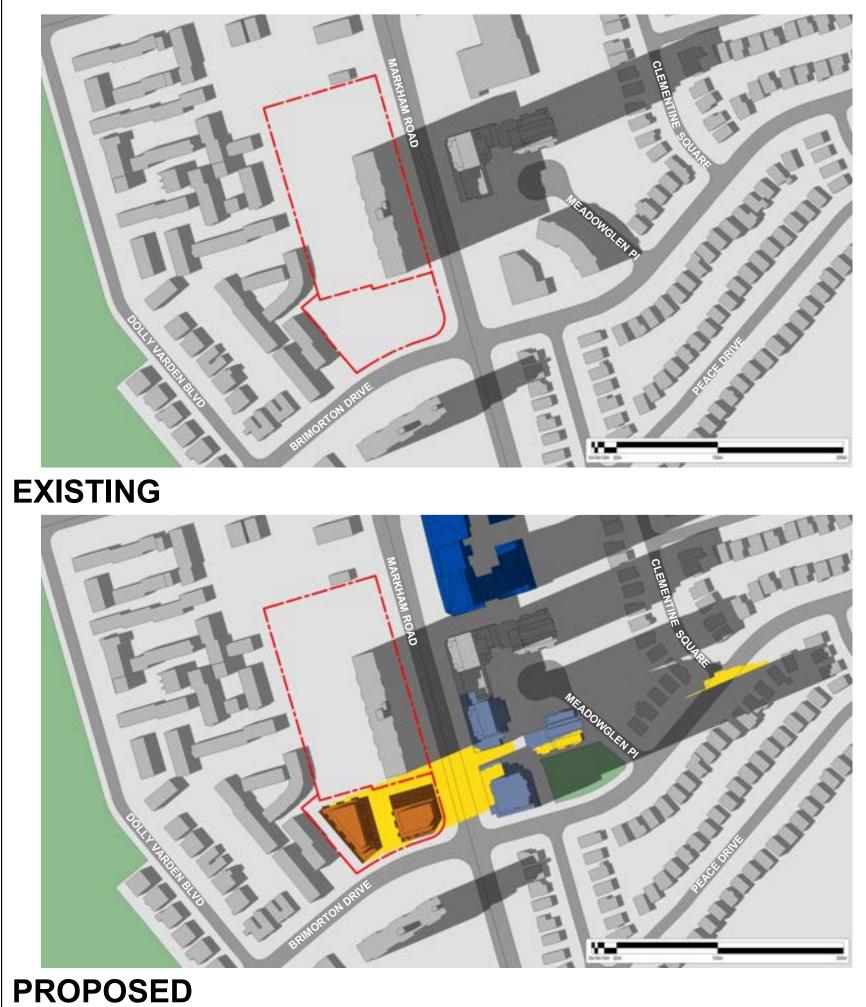

MARCH 21ST 05:18 PM

1. Copyright of this drawing is reserved by the Architect. The drawing, and all associated documents are instruments of service by the Architect. The drawing, and the information contained therein, may not be reproduced in whole or in part without prior written permission of the Architect.

2. These Contract Documents are the property of the Architect. The Architect bears no responsibility for the interpretation of these documents by the Contractor. Upon written application the Architect will provide written/graphic clarification or supplementary information regarding the intent of the Contract Documents. The Architect will review Shop Drawings submitted by the Contractor for design conformance only.

3. Drawings are not to be scaled for construction. The Contractor is to verify all existing conditions and dimensions required to perform the work and report and discrepancies with the Contract Documents to the Architect before commencing any work.

4. Positions of exposed finishes for mechanical or electrical devised, fitting and fixtures are indicated on architectural drawings. The location shown on the architectural drawing govern over the mechanical and electrical drawings. Those items not clearly located will be located as directed by the Architect.

5. These drawings are not to be used for construction unless noted below as "Issued for Construction".

All work is to be carried out in conformance with the Code and Bylaws of the Authorities having jurisdiction.

7. The Architect of these plans and specifications gives no warranty or representation to any party about the constructability of the building(s) represented by them. All contractors or subcontractors must satisfy themselves when bidding and at all times ensure that they can properly construct the work represented by these plans.


No	Issued For	Date
1	Issued for ZBA	2024-06-07

LEGEND



WALLMANARCHITECTS

99 Spadina Avenue, Suite 600 Toronto, Ontatrio M5V 3P8 t 416 340 1870 f 416 340 1871 www.wallmanarchitects.com

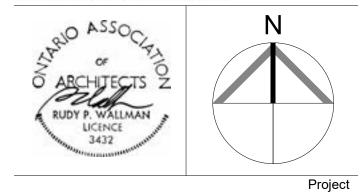

1050 Markham Road

1050 Markham Road, Toronto, Ontario, M1H 2Y5

Client

CAPREIT

Drawing Title

Drawing No.

SHADOW STUDIES MARCH


1 : 3000	Scale
	Drawn by
	Checked by
23-11	Project No.
2024-06-07	Date

A6.02



PROPOSED



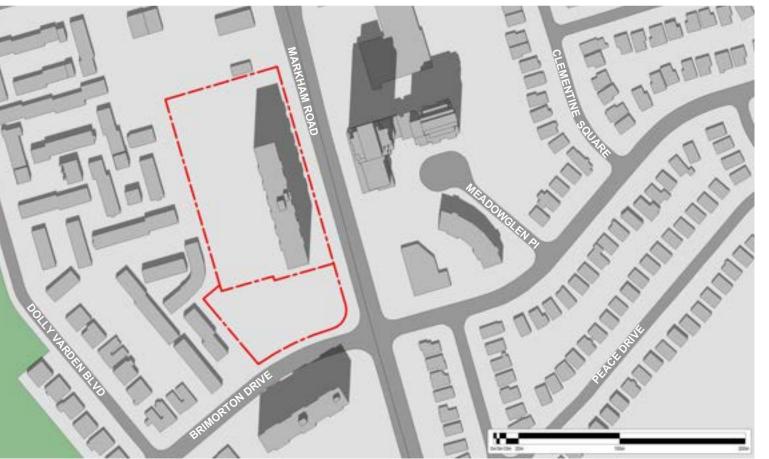


PROPOSED





TUCCU 2 P

> EXISTING PROPOSED

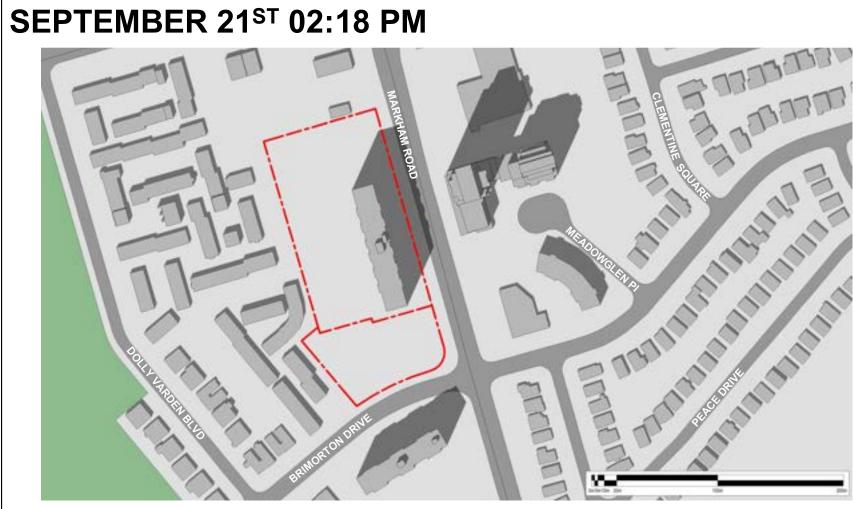

PROPOSED

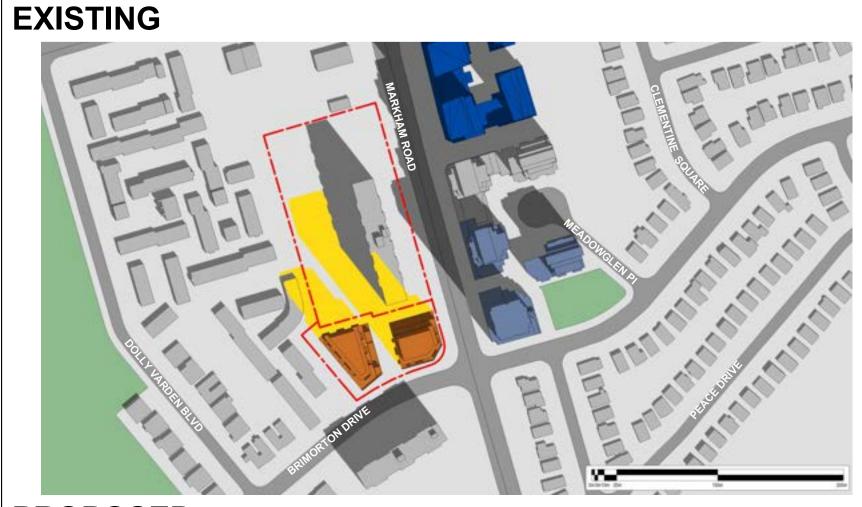

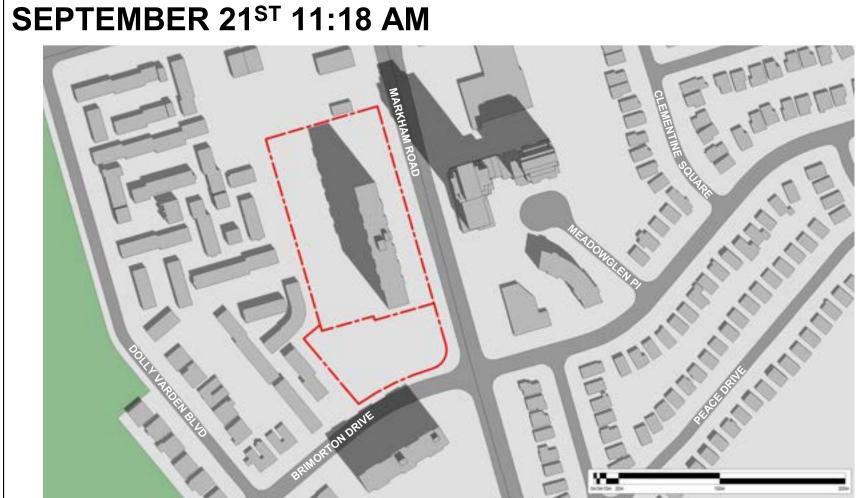



1. Copyright of this drawing is reserved by the Architect. The drawing, and all associated documents are instruments of service by the Architect. The drawing, and the information contained therein, may not be reproduced in whole or in part without prior written permission of the Architect.

2. These Contract Documents are the property of the Architect. The Architect bears no responsibility for the interpretation of these documents by the Contractor. Upon written application the Architect will provide written/graphic clarification or supplementary information regarding the intent of the Contract Documents. The Architect will review Shop Drawings submitted by the Contractor for design conformance only.

3. Drawings are not to be scaled for construction. The Contractor is to verify all existing conditions and dimensions required to perform the work and report and discrepancies with the Contract Documents to the Architect before commencing any work.

4. Positions of exposed finishes for mechanical or electrical devised, fitting and fixtures are indicated on architectural drawings. The location shown on the architectural drawing govern over the mechanical and electrical drawings. Those items not clearly located will be located as directed by the Architect.

5. These drawings are not to be used for construction unless noted below as "Issued for Construction".

6. All work is to be carried out in conformance with the Code and Bylaws of the Authorities having jurisdiction.

7. The Architect of these plans and specifications gives no warranty or representation to any party about the constructability of the building(s) represented by them. All contractors or subcontractors must satisfy themselves when bidding and at all times ensure that they can properly construct the work represented by these plans.


No	Issued For	Date
1	Issued for ZBA	2024-06-07

LEGEND



WALLMANARCHITECTS

99 Spadina Avenue, Suite 600 Toronto, Ontatrio M5V 3P8 t 416 340 1870 f 416 340 1871 www.wallmanarchitects.com

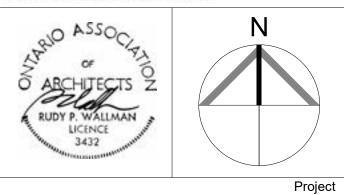

1050 Markham Road

1050 Markham Road, Toronto, Ontario, M1H 2Y5

Client

CAPREIT


Drawing Title


SHADOW STUDIES SEPTEMBER


1:3000	Scale
	Drawn by
	Checked by
23-11	Project No.
2024-06-07	Date


A6.03

Drawing No.

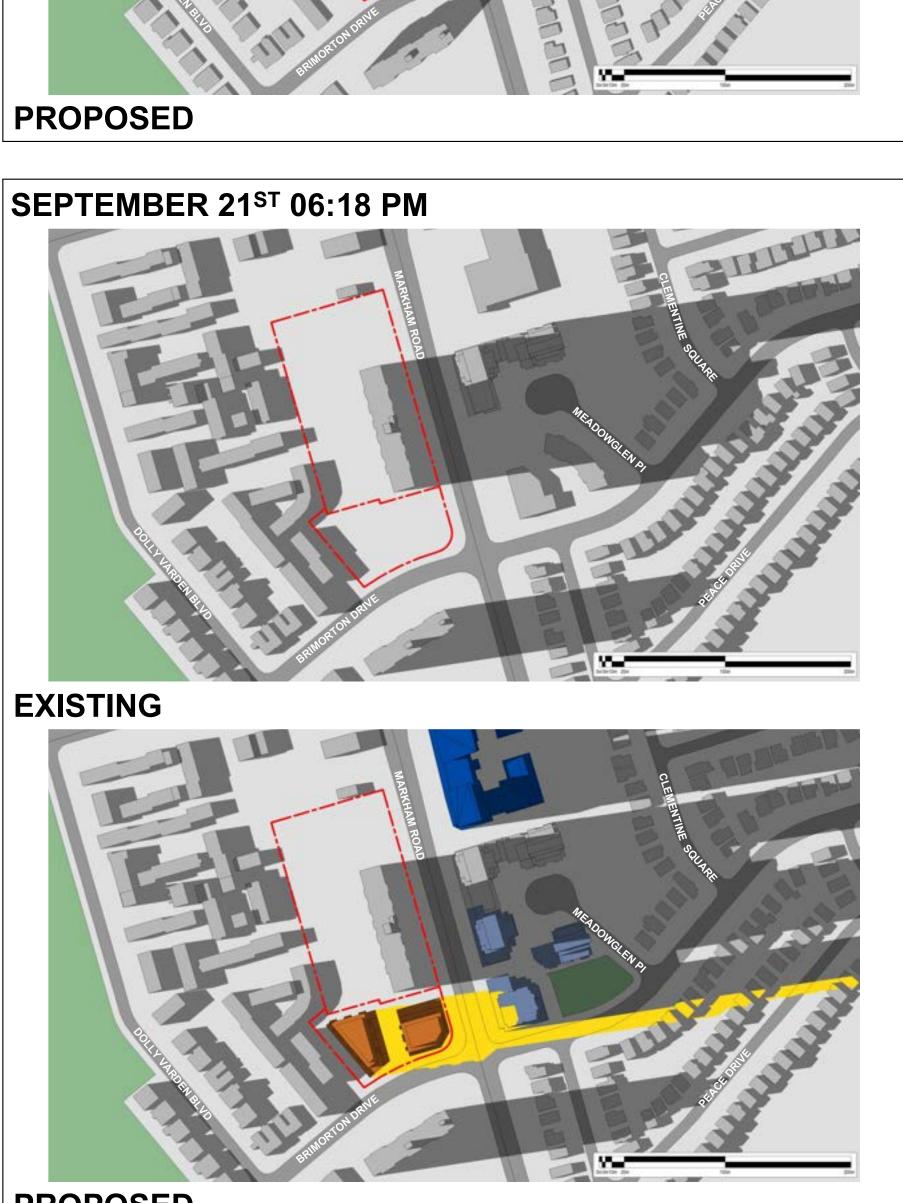

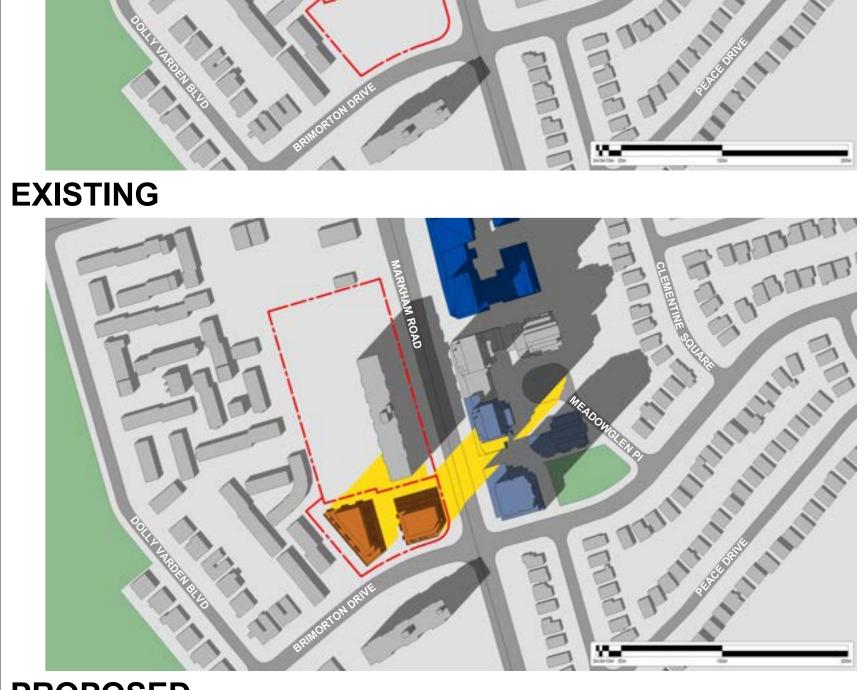


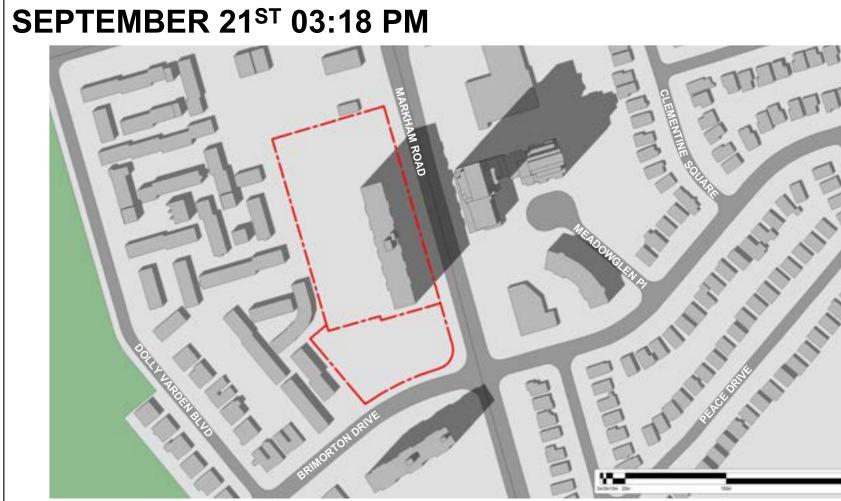

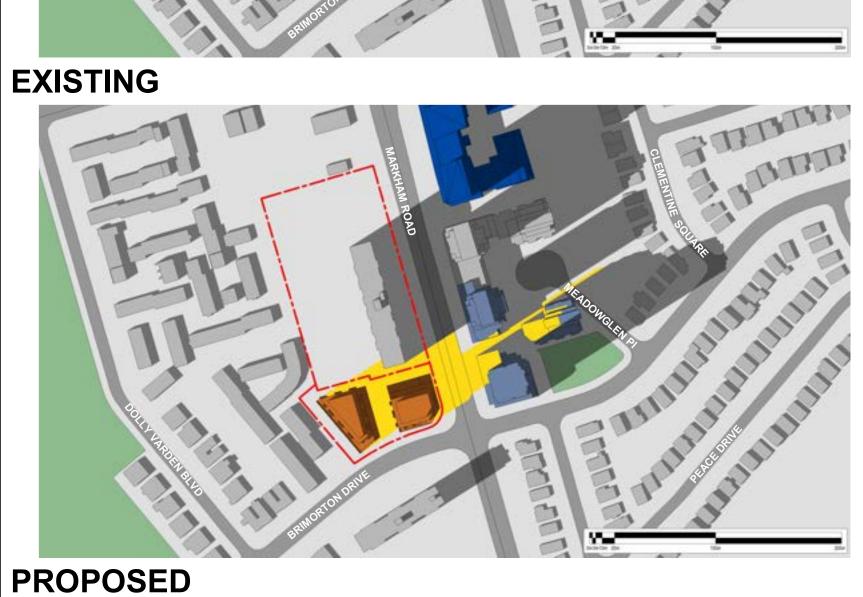

SEPTEMBER 21ST 04:18 PM



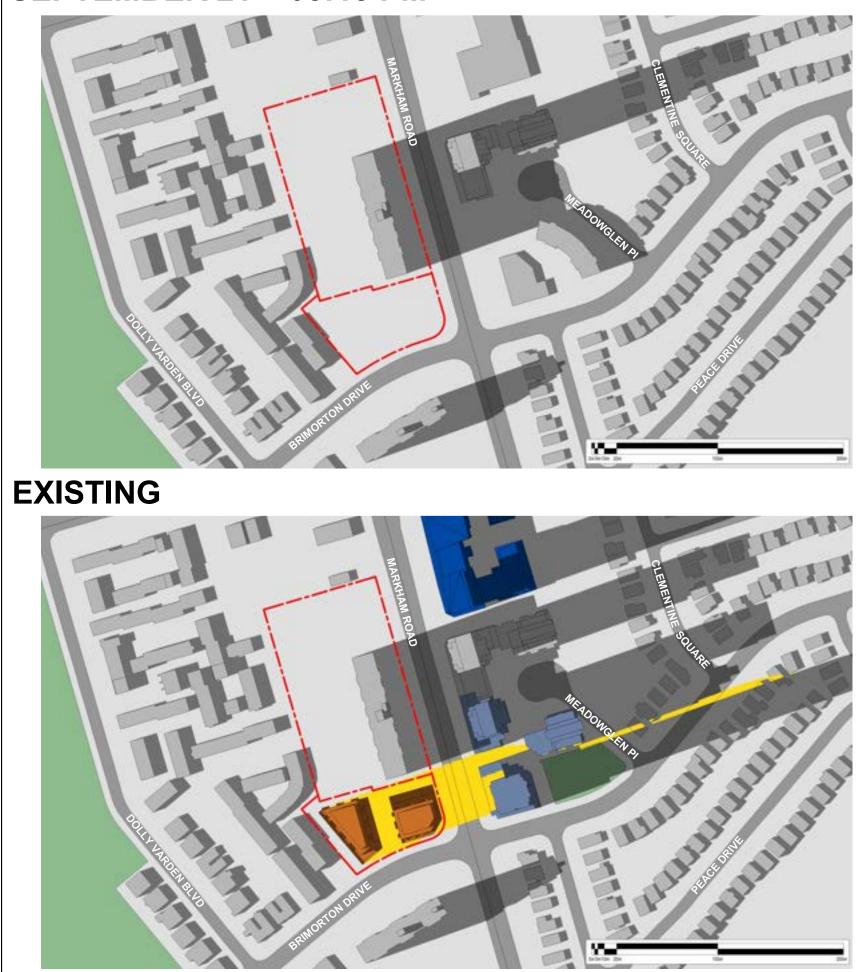

PROPOSED

SEPTEMBER 21ST 05:18 PM

1. Copyright of this drawing is reserved by the Architect. The drawing, and all associated documents are instruments of service by the Architect. The drawing, and the information contained therein, may not be reproduced in whole or in part without prior written permission of the Architect.

2. These Contract Documents are the property of the Architect. The Architect bears no responsibility for the interpretation of these documents by the Contractor. Upon written application the Architect will provide written/graphic clarification or supplementary information regarding the intent of the Contract Documents. The Architect will review Shop Drawings submitted by the Contractor for design conformance only.

3. Drawings are not to be scaled for construction. The Contractor is to verify all existing conditions and dimensions required to perform the work and report and discrepancies with the Contract Documents to the Architect before commencing any work.

4. Positions of exposed finishes for mechanical or electrical devised, fitting and fixtures are indicated on architectural drawings. The location shown on the architectural drawing govern over the mechanical and electrical drawings. Those items not clearly located will be located as directed by the Architect.

5. These drawings are not to be used for construction unless noted below as "Issued for Construction".

All work is to be carried out in conformance with the Code and Bylaws of the Authorities having jurisdiction.

7. The Architect of these plans and specifications gives no warranty or representation to any party about the constructability of the building(s) represented by them. All contractors or subcontractors must satisfy themselves when bidding and at all times ensure that they can properly construct the work represented by these plans.


No	Issued For	Date
1	Issued for ZBA	2024-06-07

LEGEND



WALLMANARCHITECTS

99 Spadina Avenue, Suite 600 Toronto, Ontatrio M5V 3P8 t 416 340 1870 f 416 340 1871 www.wallmanarchitects.com

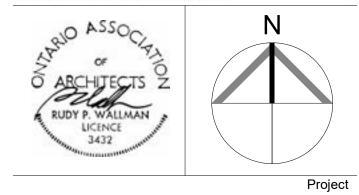

1050 Markham Road

1050 Markham Road, Toronto, Ontario, M1H 2Y5

Client

CAPREIT

Drawing Title

SHADOW STUDIES SEPTEMBER

1 : 3000	Scale
	Drawn by
	Checked by
23-11	Project No.
2024-06-07	Date

A6.04

Drawing No.